

454 - 456 DONCASTER ROAD DONCASTER CHILDCARE CENTRE

Sheet Index				
Layout ID	Layout Name	Revision	Issued	Published
A000	COVER SHEET	02	\boxtimes	\boxtimes
A200	SITE ANALYSIS - EXISTING CONDITIONS	02	\boxtimes	\boxtimes
A201	TREE PROTECTION ZONE	2	\boxtimes	\boxtimes
A221	SITE PLAN - BUILDING SET BACKS	02	\boxtimes	\boxtimes
A237	PROPOSED SHADOW DIAGRAM 9AM 22 S	2	\square	\boxtimes
A238	PROPOSED SHADOW DIAGRAM 10 AM 22	2	\square	\square
A239	PROPOSED SHADOW DIAGRAM 11 AM 22	2	\square	\square
A240	PROPOSED SHADOW DIAGRAM 12PM 22 S	2	\square	\square
A241	PROPOSED SHADOW DIAGRAM 1PM 22 S	2	\square	\square
A242	PROPOSED SHADOW DIAGRAM 2PM 22 S	2	\boxtimes	\bowtie
A243	PROPOSED SHADOW DIAGRAM 3PM 22 S	2	\square	\square
A2000	FLOOR PLAN LOWER BASEMENT	02	\square	\square
A2001	FLOOR PLAN - UPPER BASEMENT (VISITO	02	\square	\square
A2002	Floor Plan - Ground Floor	02	\square	\square
A2003	Floor Plan - First Floor	02	\square	\square
A2004	Floor Plan - Second Floor	02	\square	\square
A2005	Roof Plans/SET BACKS	02	\boxtimes	\bowtie
A2006	TP ENDORSED GROUNDFLOOR PLAN	4	\boxtimes	\bowtie
A2007	TP ENDORSED FIRST FLOOR PLAN	4	\boxtimes	\boxtimes
A2008	TP ENDORSED SECOND FLOOR	4	\square	\square
A2009	TP ENDORSED ROOF PLAN	4	\square	\square
A2100	STRUCTURAL RETAINING WALL PLAN	2	\square	\square
A3000	ELEVATION	02	\square	\square
A3001	ELEVATION	2	\square	\square
A3002	ELEVATION	2	\square	\square
A3003	ELEVATION	02	\boxtimes	\square
A3004	ELEVATIONS STREETSCAPE	2	\boxtimes	\square

CLIENT	
GLIENT	

KANE BARNETT

		Area	Square Meters (m ²)	Kids	Staff
ROOFED AREA	219.00	INTERNAL			
SECOND FLOOR	633.00	GROUND FLOOR			
FIRST FLOOR	944.00	Play Room 1	52	16	2
		Play Room 2 U3,S	52	16	4
GROUNDFLOOR	1160.00	Play Room 3 U3'S	52	13	4
UPPER BASEMENT	974.00	Play Room 4	52	16	2
LOWER BASEMENT	974.00	Play Room 5	72	22	2
		Total:	280	83	14
		FIRST FLOOR			
		Play Room 6	73	22	2
		Play Room 7	72	22	2
		Play Room 8	73	22	2
		Play Room 9	72	22	2
		2ND FLOOR Play Room 10	86	22	2
		Total:	656	193	24
		Grand Total:	936	276	38
		Area	Square Meters (m²)	Kids	Staff
		EXTERNAL			
		Play Ground 1 (GF)	97	13.8	
		Play Ground 2 (GF)	391	55.8	
		Play Ground 3 (FF)	463	66.14	
		Play Ground 4 (SF)	408	58.2	
		Total:	1359	193.94	
Total	4904.00			Parking spaces	Disable Parking
		External Parking		0	v
		upper Basement visitors		22	
Site Coverage (approximately) m ²	928.00	lower Basement parking		27	0
Site Coverage (approximately)	58.1%	Total:		49	0
		1			
permeable area (approximately) m2	453.00				
permeable area %	28.3%	7			

	5
Remark	L
	Ą
	Ą
	Ą
	Ą
	(

Sheet Index									
Layout ID	Layout Name	Revision	Issued	Published	Remark				
A3100	SECTIONS	02		\boxtimes					
A9000	FENCES DETAIL	2		\boxtimes					
A9001	SIGNAGE DETAIL	2		\boxtimes					
A9002	SCHEDULES	3		\boxtimes					
COVER SH	Rendered view	3		\square					

Date				Project Status	
14/03/2018		Modified by	Date		Drawing Name
22/11/2018		DE	28/06/2019		COVER SHEET
3/12/2018					COVER SHEET
28/06/2019	Drawing Scale	Checked by	Date	TOWN PLANNING	
	4.4 @ 44	Checked by	Date		
	1:1 @A1	DE	28/06/2019		
			20/00/2010		









SITE ANALYSI	S	NOTATIONS	LEGEND
454-456 DONCASTER ROAD DONCASTER		ALL LEVELS SHOWN THUS $+ 6^{i e^{i \sqrt{9}}}$ AND CONTOURS ARE CONNECTED TO THE AUSTRALIAN HEIGHT DATUM USING PERMANENT MARK BULLEEN PM 139 (R.L.38·343) ALL FENCING SHOWN ON THIS PLAN HAS BEEN EXAGGERATED FOR THE PURPOSE OF CLARITY CONTOUR INTERVAL : 0·25m ALL FENCE AND TREE HEIGHTS SHOWN ARE APPROXIMATE ONLY. W: WINDOW UW: UPPER STOREY WINDOW D: DOOR G: GARAGE NW: NON-HABITABLE WINDOW	 HOT WATER UNIT AIR COND UNIT FIRE HYDRANT SIGN GAS METER TELSTRA PIT ELEC. POLE WATER VALVE
SCALE <u>1 1 1</u> 0 1·5 3 4·5 6 7·5 LENGTHS ARE IN METRES	ORIGINAL SCALE SHEET SIZE 1: 150 A0	NW: NUN-HABITABLE WINDOW ALL WINDOWS SHOWN ARE HABITABLE UNLESS OTHERWISE NOTED. <u>NOTE:</u> THIS PLAN HAS BEEN PROVIDED AS A HARD COPY PLAN AND ALSO IN DIGITAL FORMAT. THE HARD COPY TAKES PRECEDENCE OVER THE DIGITAL DATA & NO GUARANTEE CAN BE GIVEN TO TRANSFER OF DATA TO ANOTHER SYSTEM.	GRATED PIT WATER METER TAP SEWER VENT ESEWER PIT (SQUARE) -D- SEWER INSPECTION PIT
BT SURVEYS PTY.LTD. 1/34 DEEPDENE ROAD, BALWYN 3103 PHONE/FAX 9817 6293 MOBILE 0412 567 778 EMAIL btsurveys@optusnet.com.au	SURVEYORS REF. 176115A COMPUTER REF. 176115A.DWG	DATE OF SURVEY: 21/06/17 & 30/10/18 SURVEYOR: BT, CP, JT & DM ⊗ NAIL IN FENCE PLACED DRAWN: GC © RIVET IN CONCRETE PLACED CHECKED: BT ■ TITLE PEG PLACED	 ✓ FENCE POST ⊗ SEWER PIT (ROUND) ☑ DRAINAGE PIT
	CLIENT		

RevID	ChID	Change Name	
01			
0			
1			
02			


KANE BARNETT

Date				Project Status	
14/03/2018		Modified by	Date		Drawing Name
22/11/2018		DE	28/06/2019		SITE ANALYSIS - EXISTING
3/12/2018					
28/06/2019	Drawing Scale	Checked by	Date	TOWN PLANNING	CONDITIONS
	1:207 @A1				
		DE	28/06/2019		









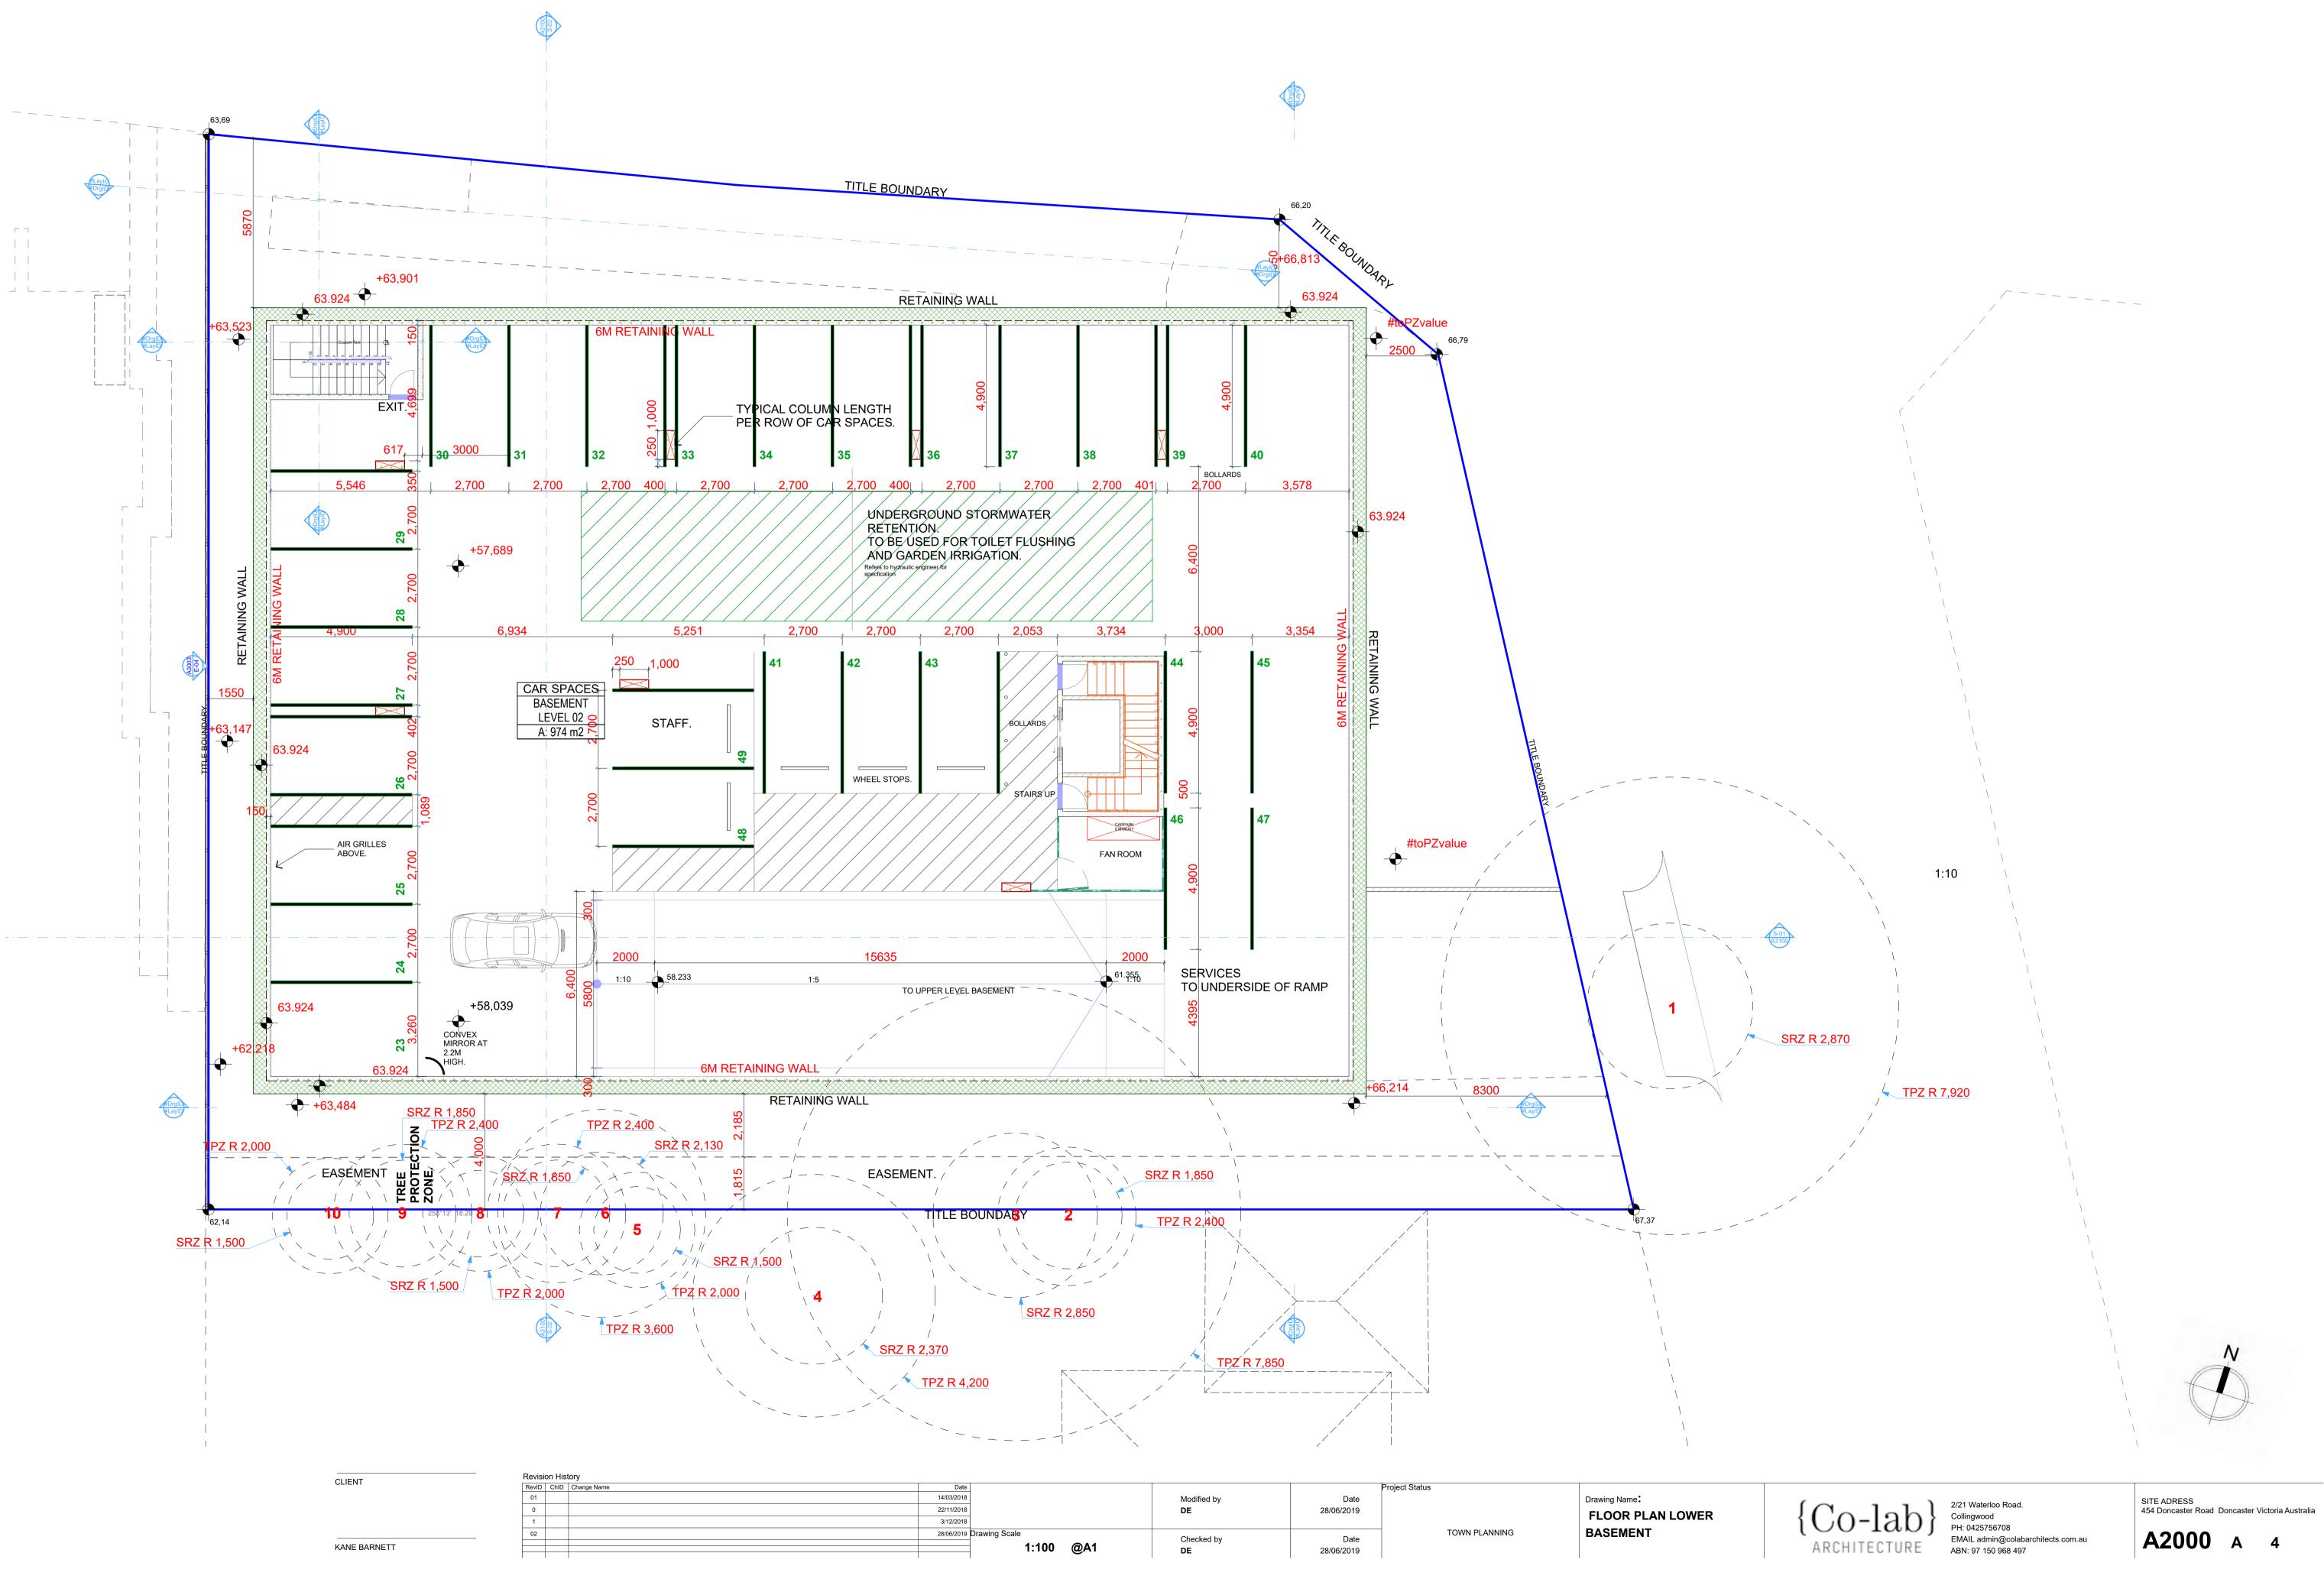

14/03/2018		Modified by	Date		Drawing Name
22/11/2018		DE	28/06/2019		FLOOR PLAN LOWER
3/12/2018					
28/06/2019	Drawing Scale	Checked by	Date	TOWN PLANNING	BASEMENT
	4.400 @44	Checked by	Date		
	1:100 @A1	DE	28/06/2019		

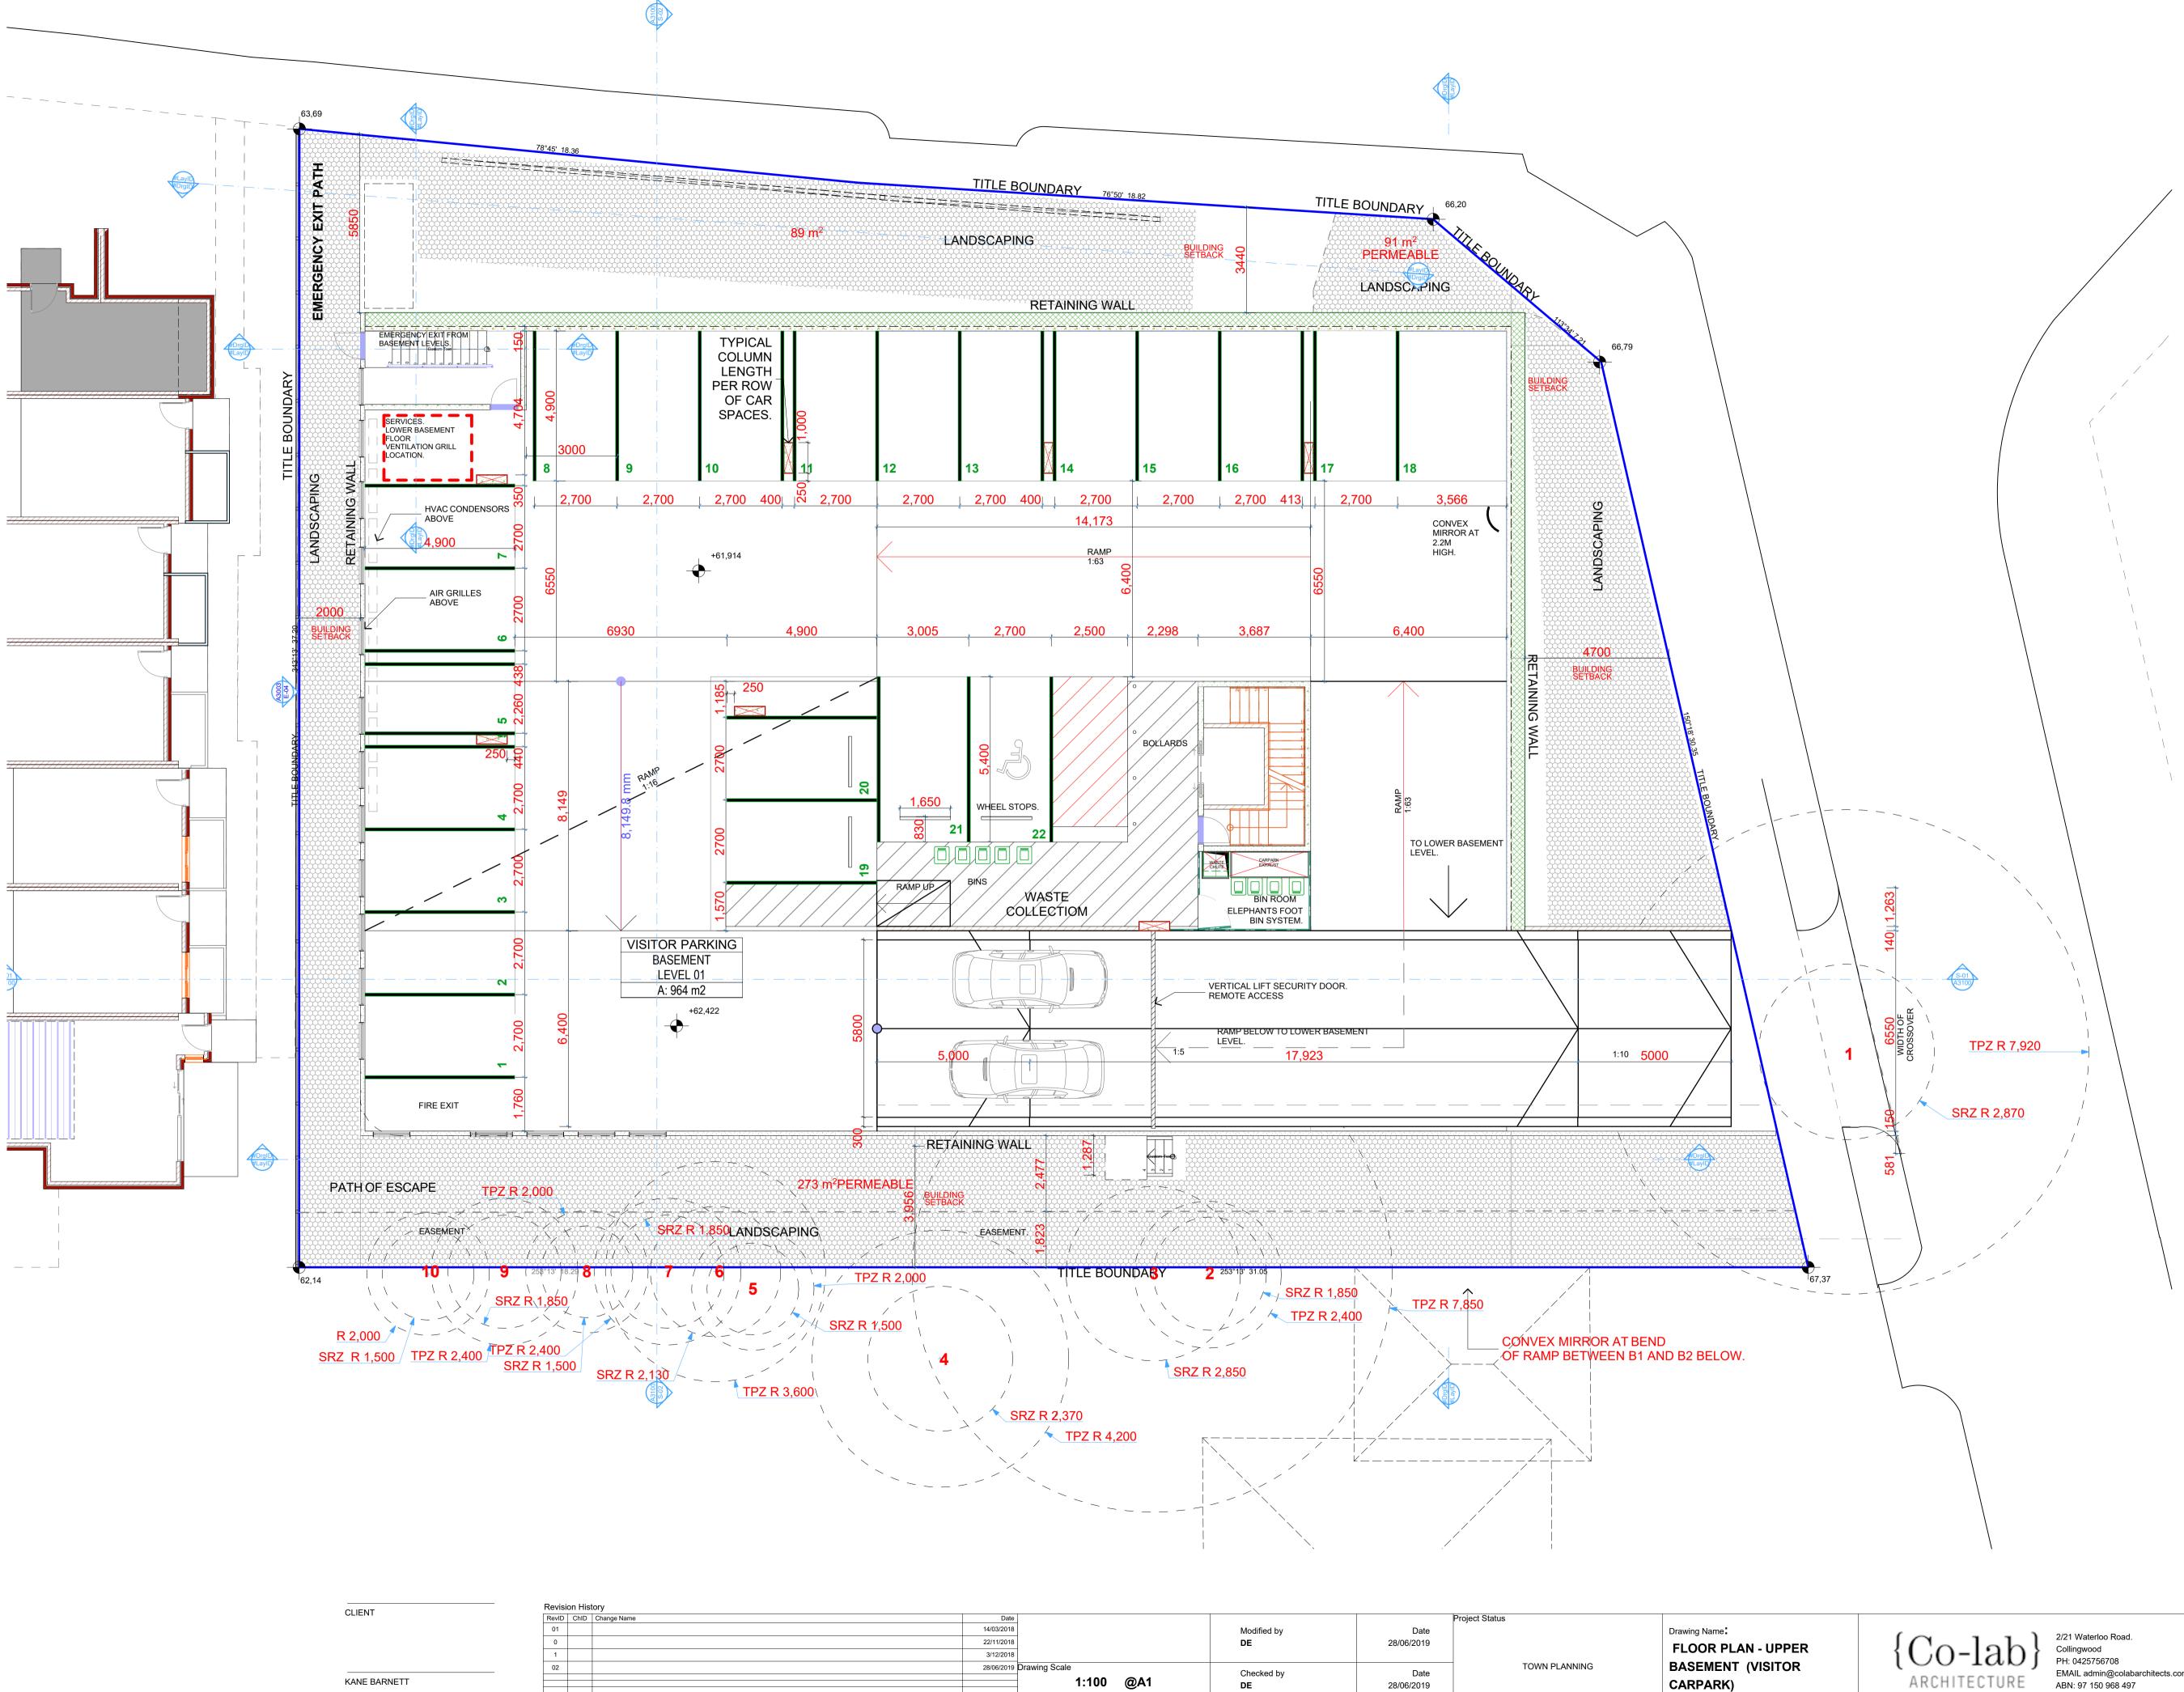


	Revision History					
	RevID	ChID	Change Name			
	01					
	0					
	1					
	02					
ARNETT						

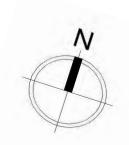

EMAIL admin@colabarchitects.com.au ABN: 97 150 968 497

SITE ADRESS 454 Doncaster Road Doncaster Victoria Australia

A2001 A 4

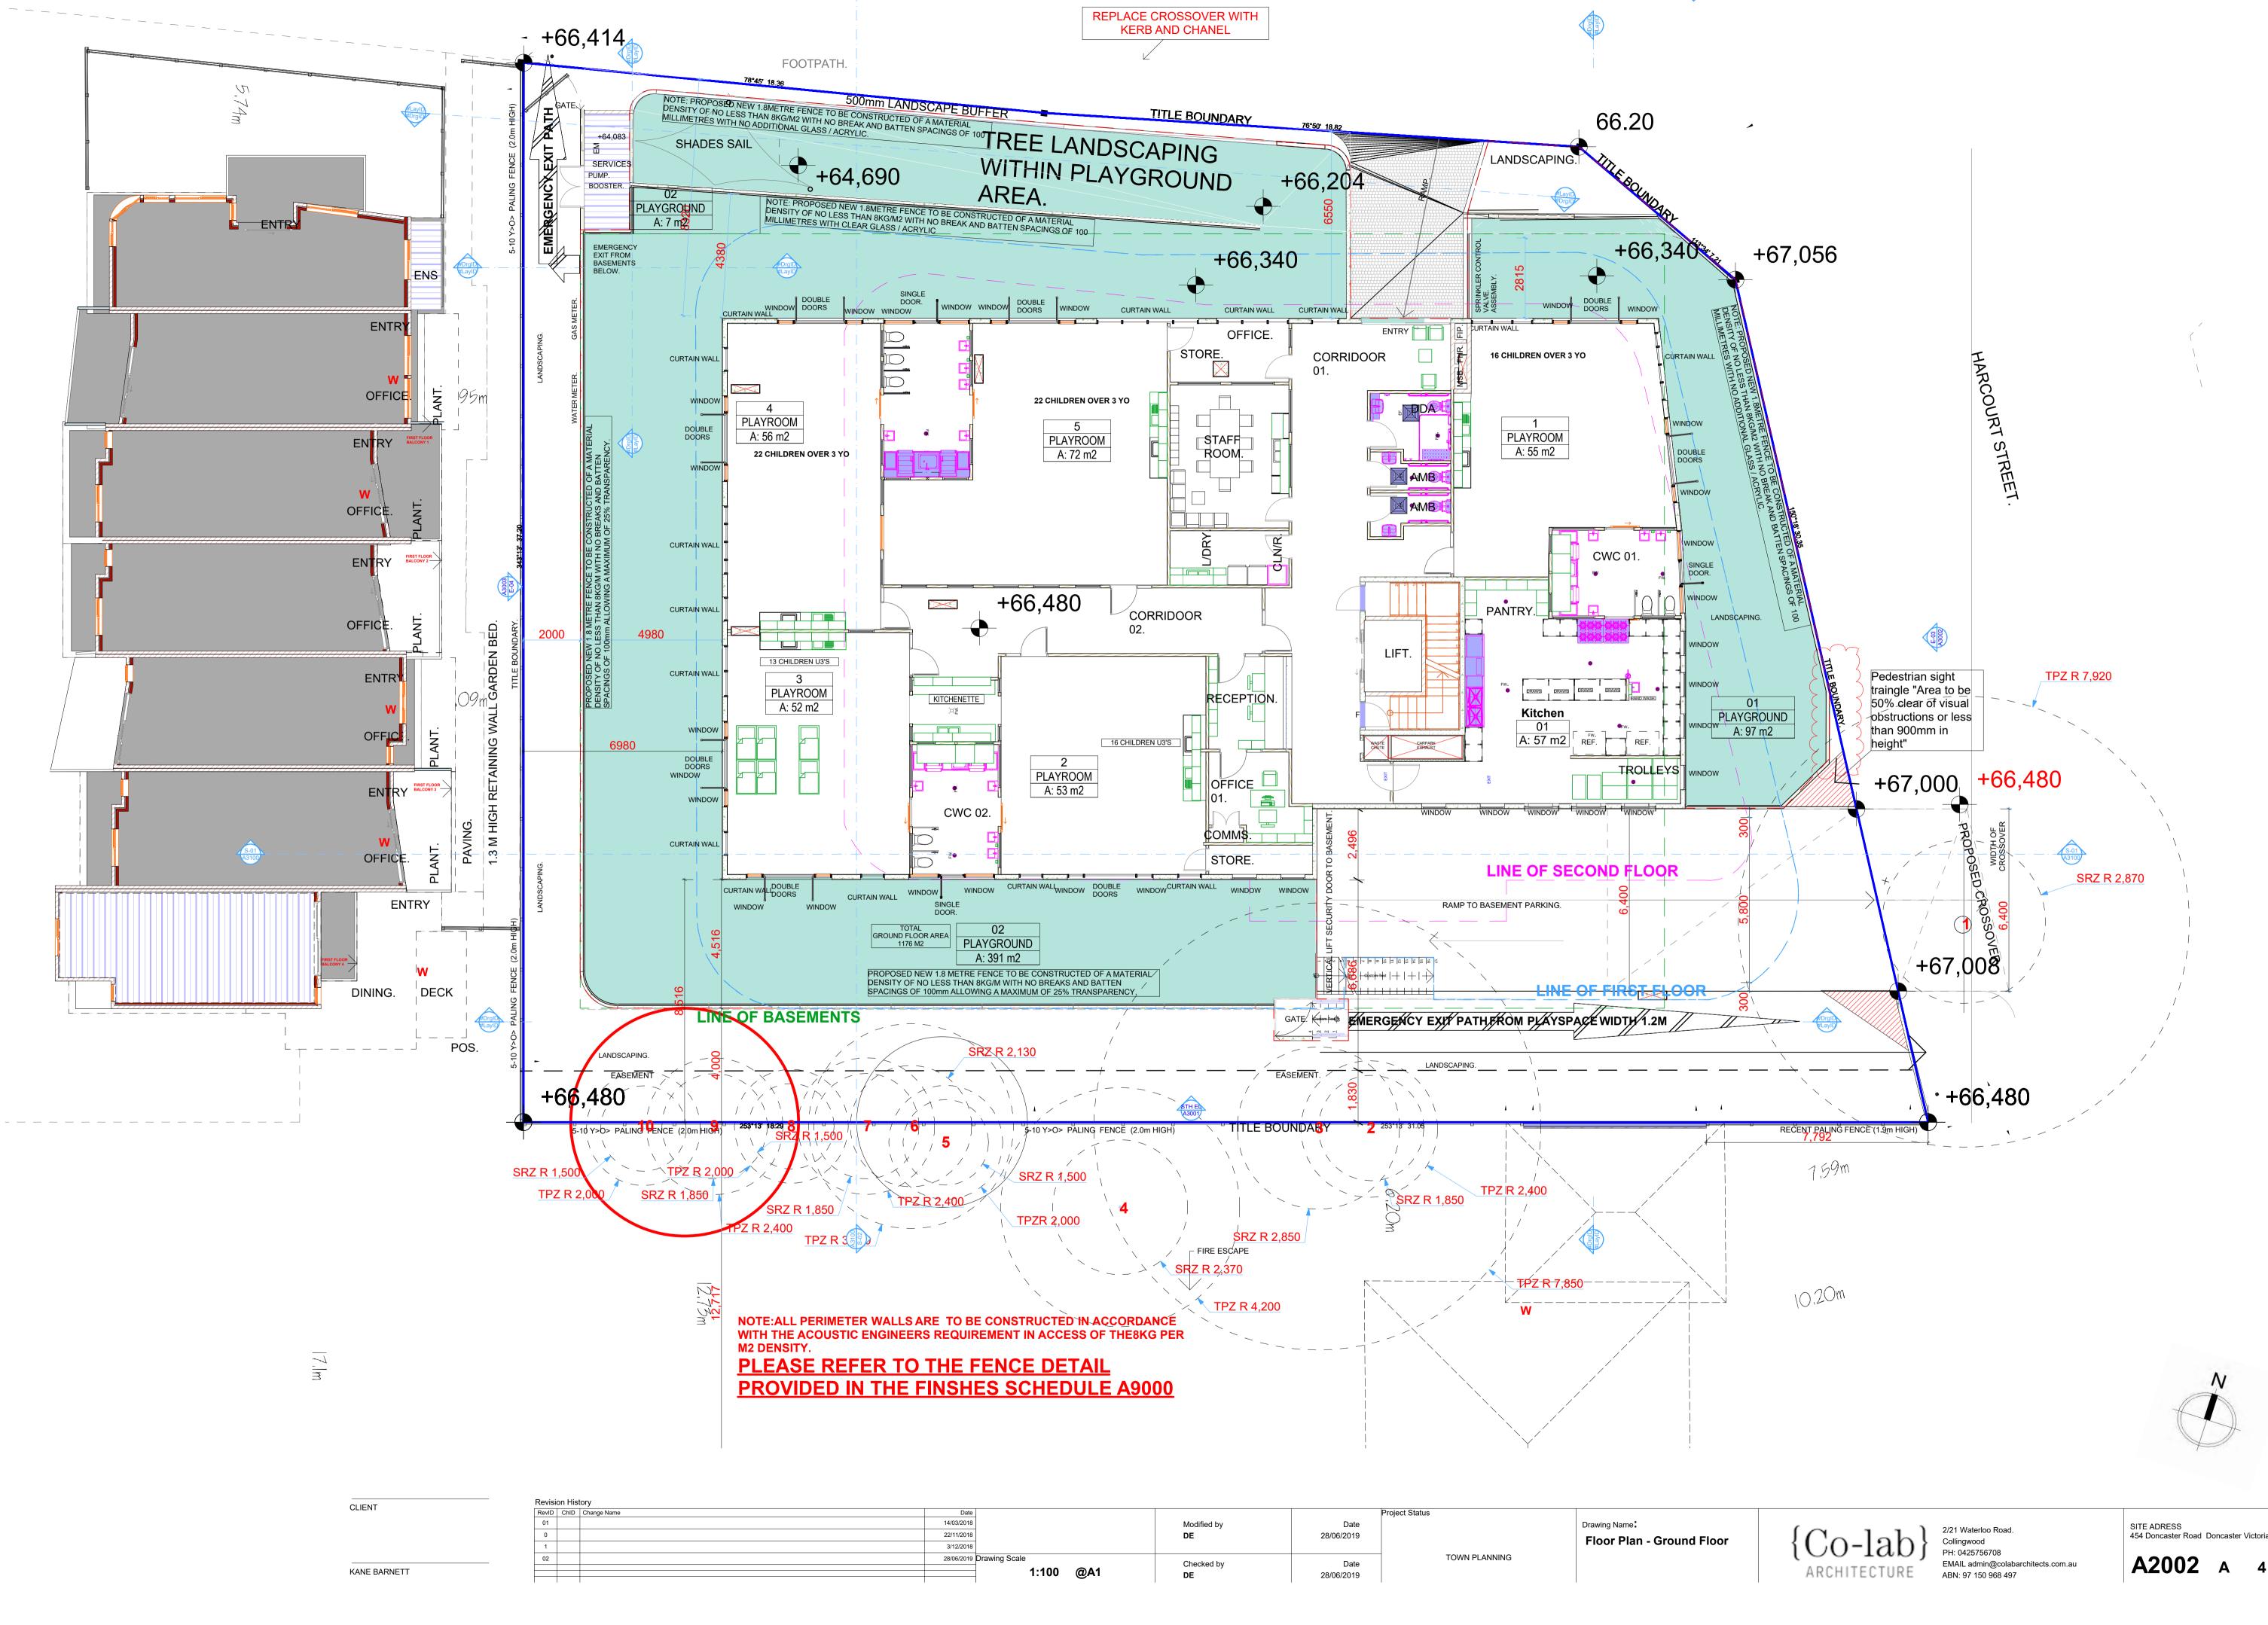




-- -

Date 14/03/2018 22/11/2018 3/12/2018		Modified by DE	Date 28/06/2019	Project Status	Drawing Name: Floor Plan - Ground Floor
	Drawing Scale 1:100 @A1	Checked by DE	Date 28/06/2019	TOWN PLANNING	

A3000 E-01

454 Doncaster Road Doncaster Victoria Australia

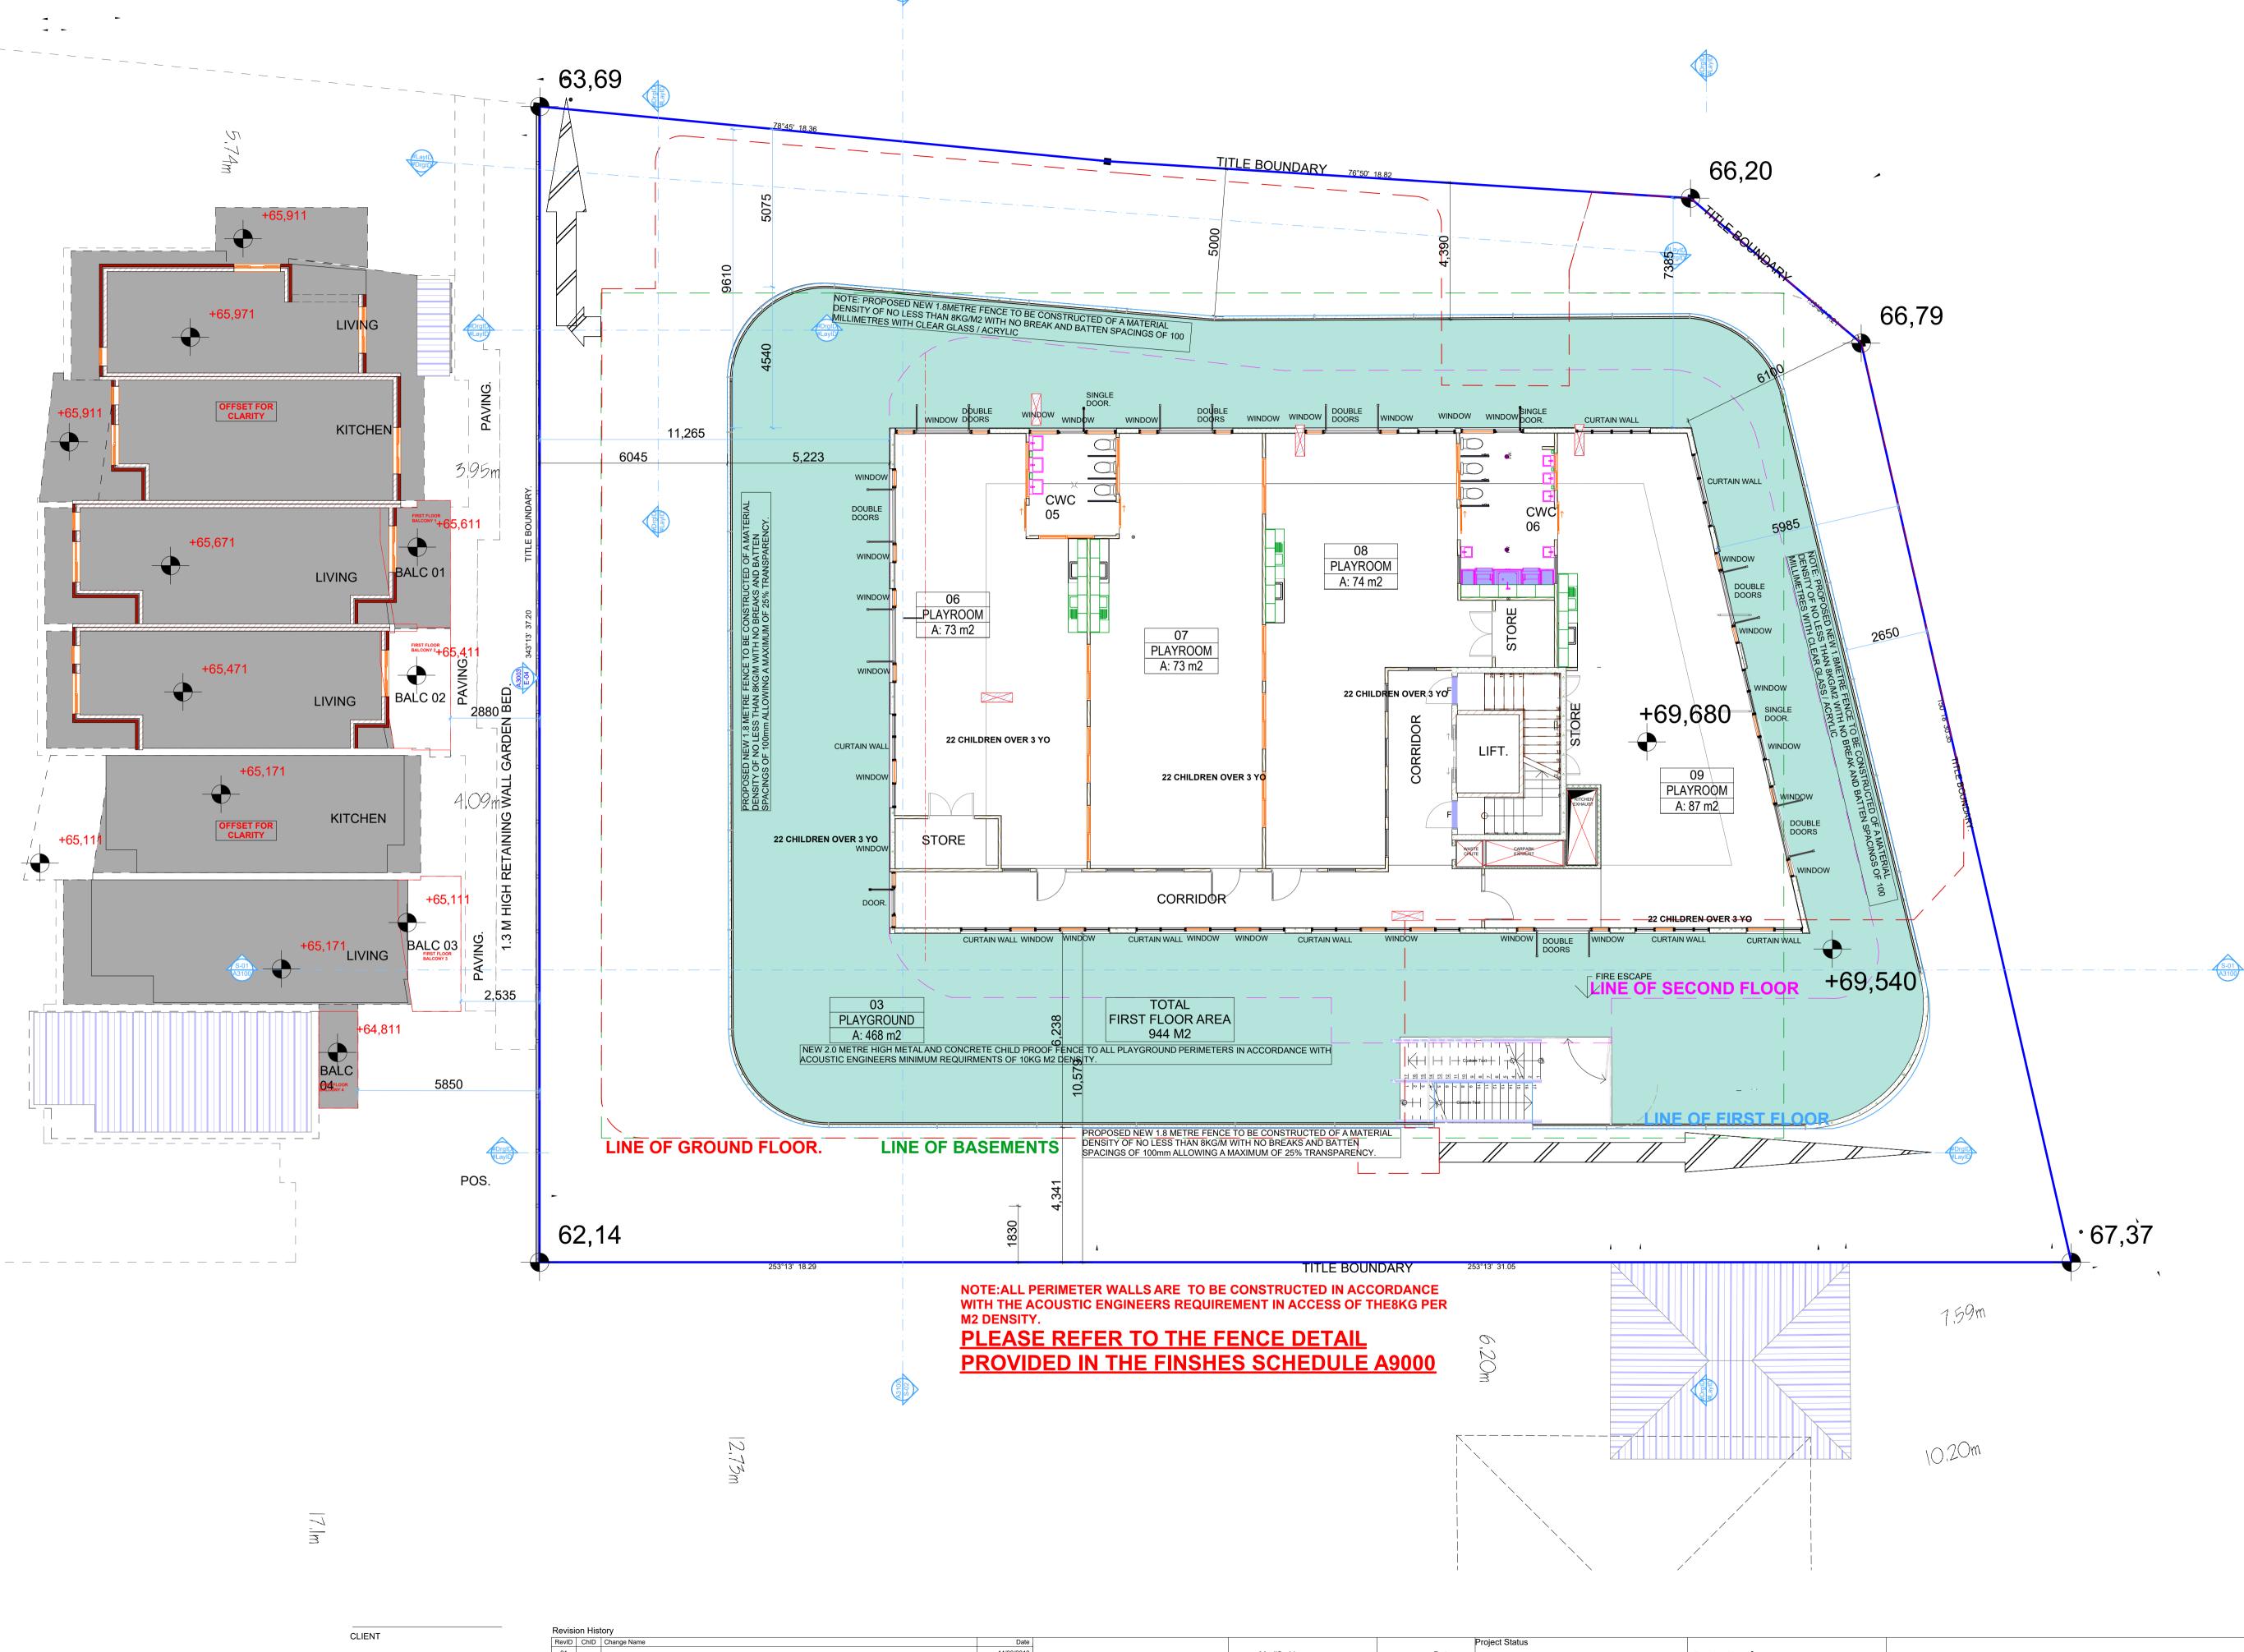


CLIENT	

KANE BARNETT

Revisi	on Hist	tory
RevID	ChID	Change Name
01		
0		
1		
02		


	Dale					1
	14/03/2018		Modified by	Date		Drawing Name
	22/11/2018		DE	28/06/2019		Floor Plan - First Floor
	3/12/2018					
	28/06/2019	Drawing Scale	Checked by	Date	TOWN PLANNING	
		4.400 @A4	Checked by	Date		
		1:100 @A1	DE	28/06/2019		
I						l

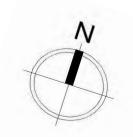





2/21 Waterloo Road. Collingwood PH: 0425756708 EMAIL admin@colabarchitects.com.au ABN: 97 150 968 497 SITE ADRESS 454 Doncaster Road Doncaster Victoria Australia


A2003 A 4

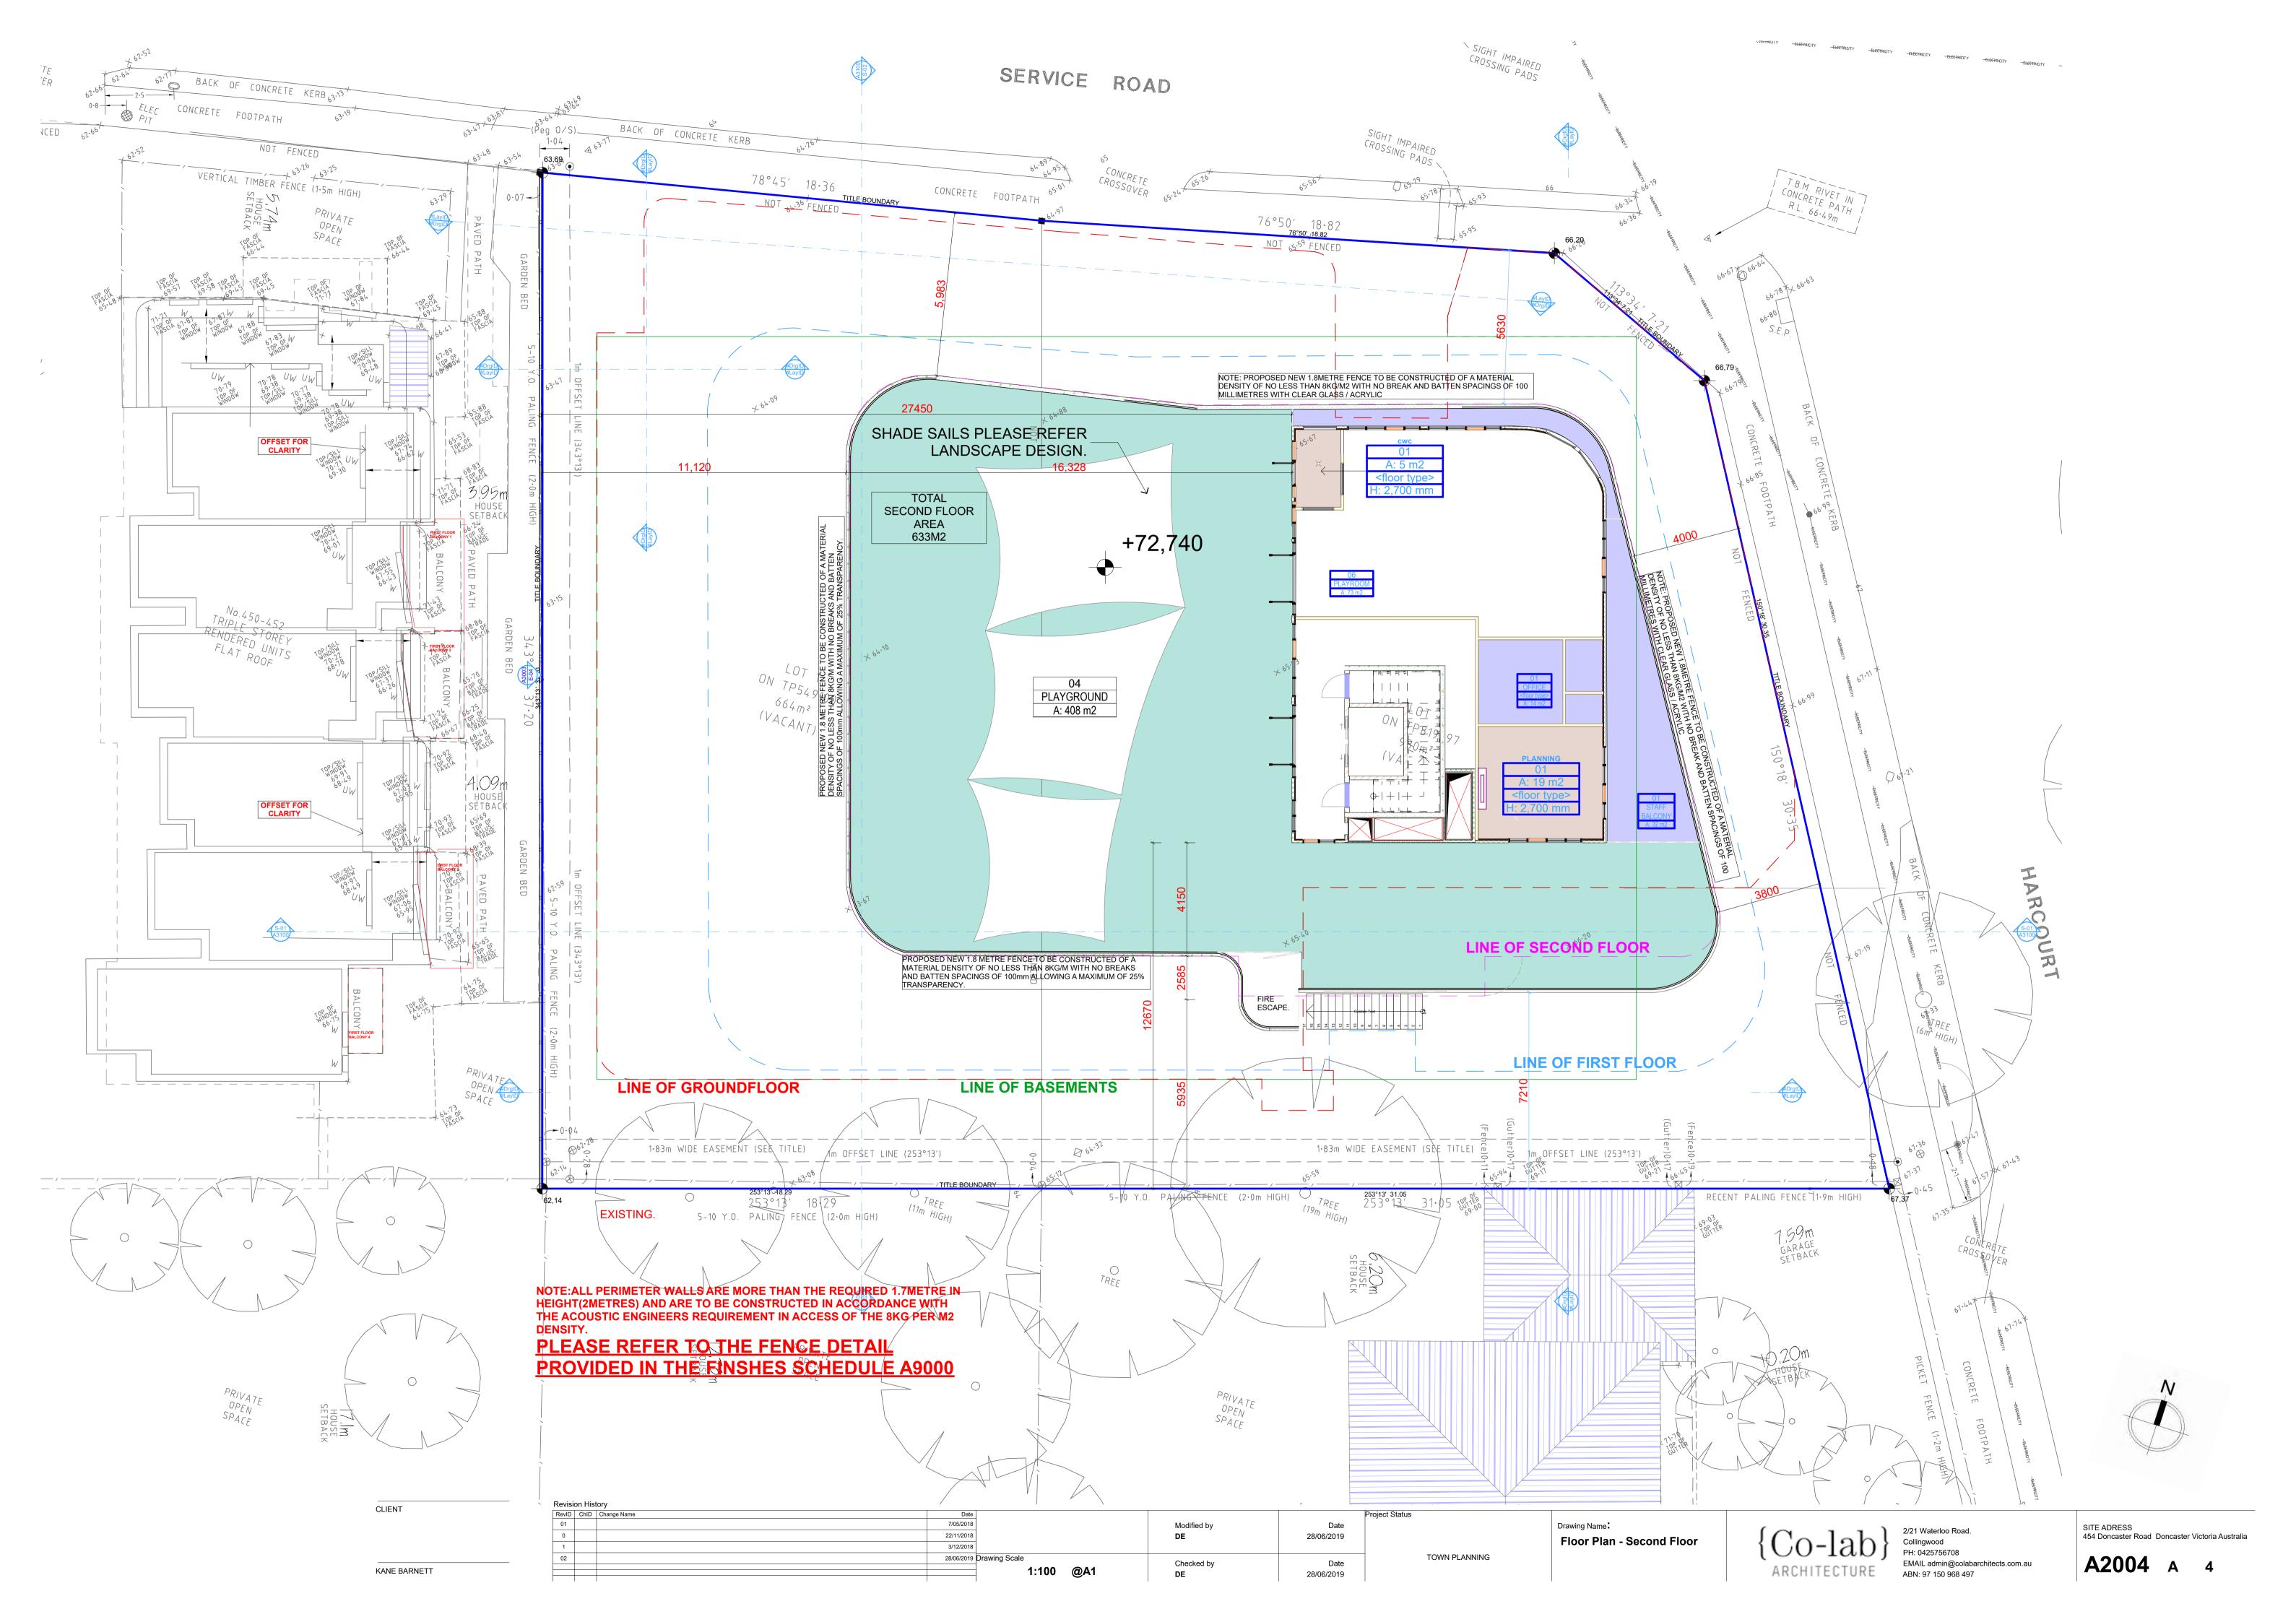

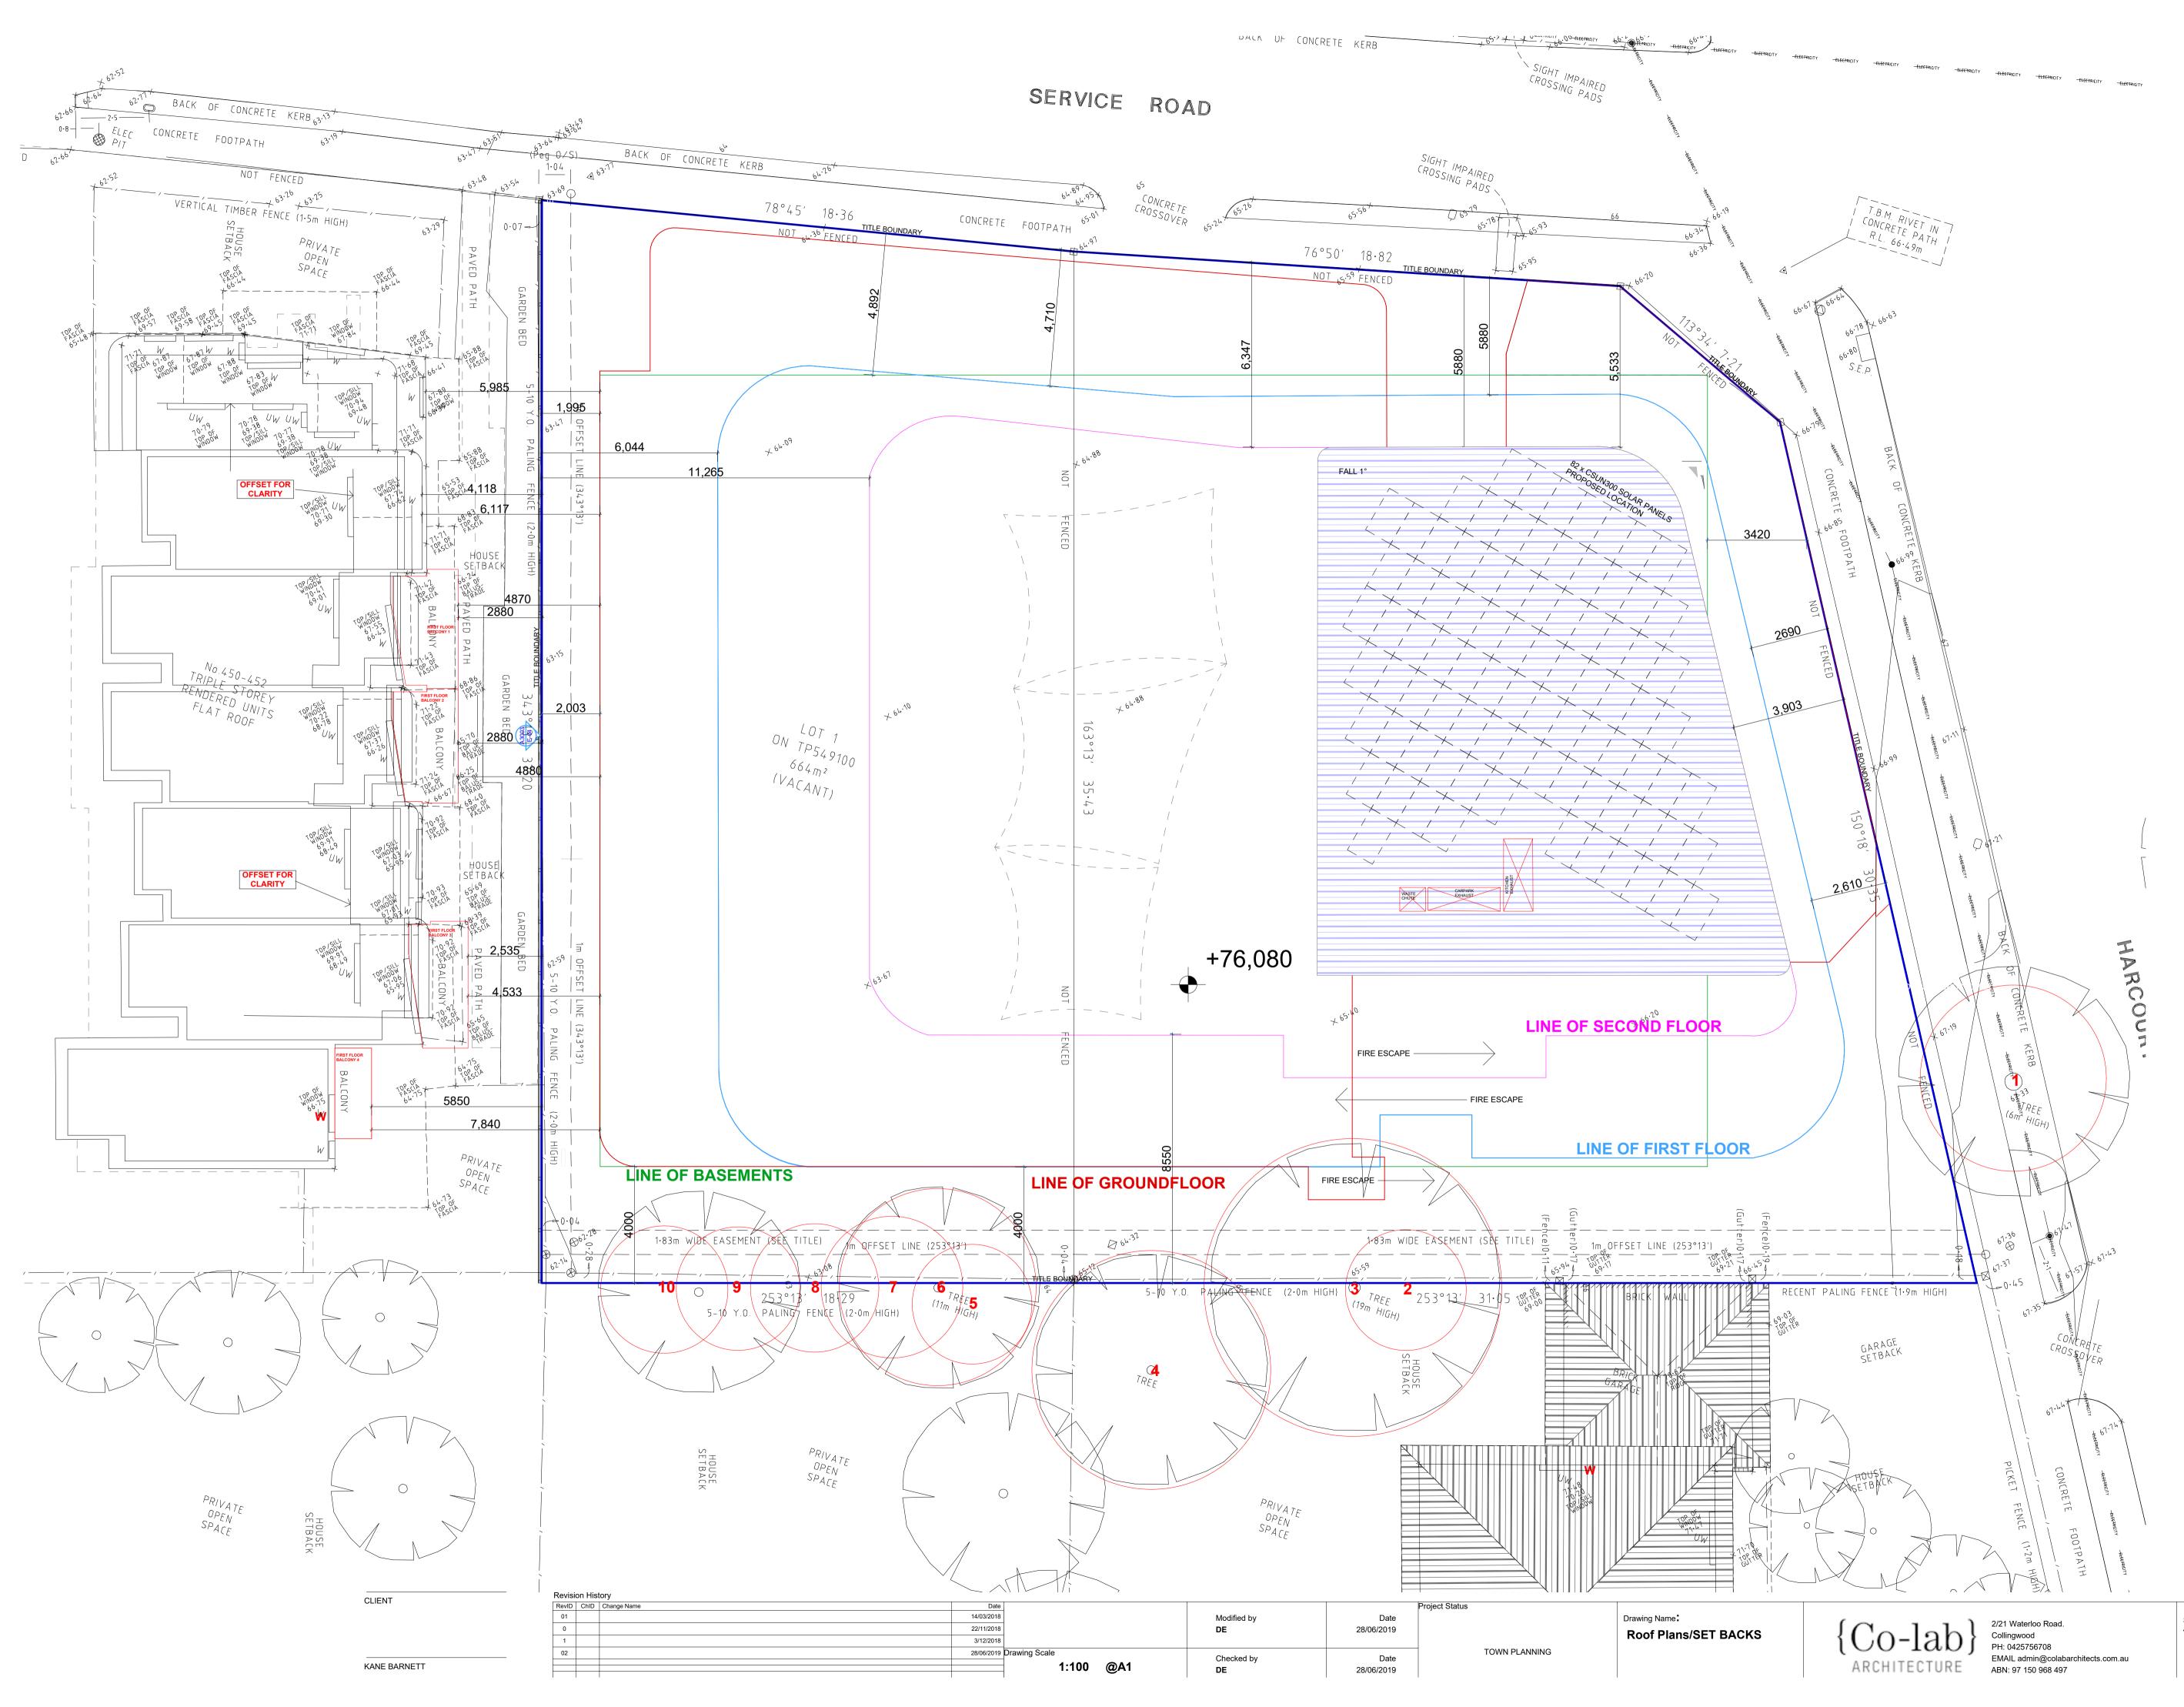

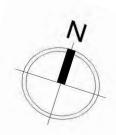



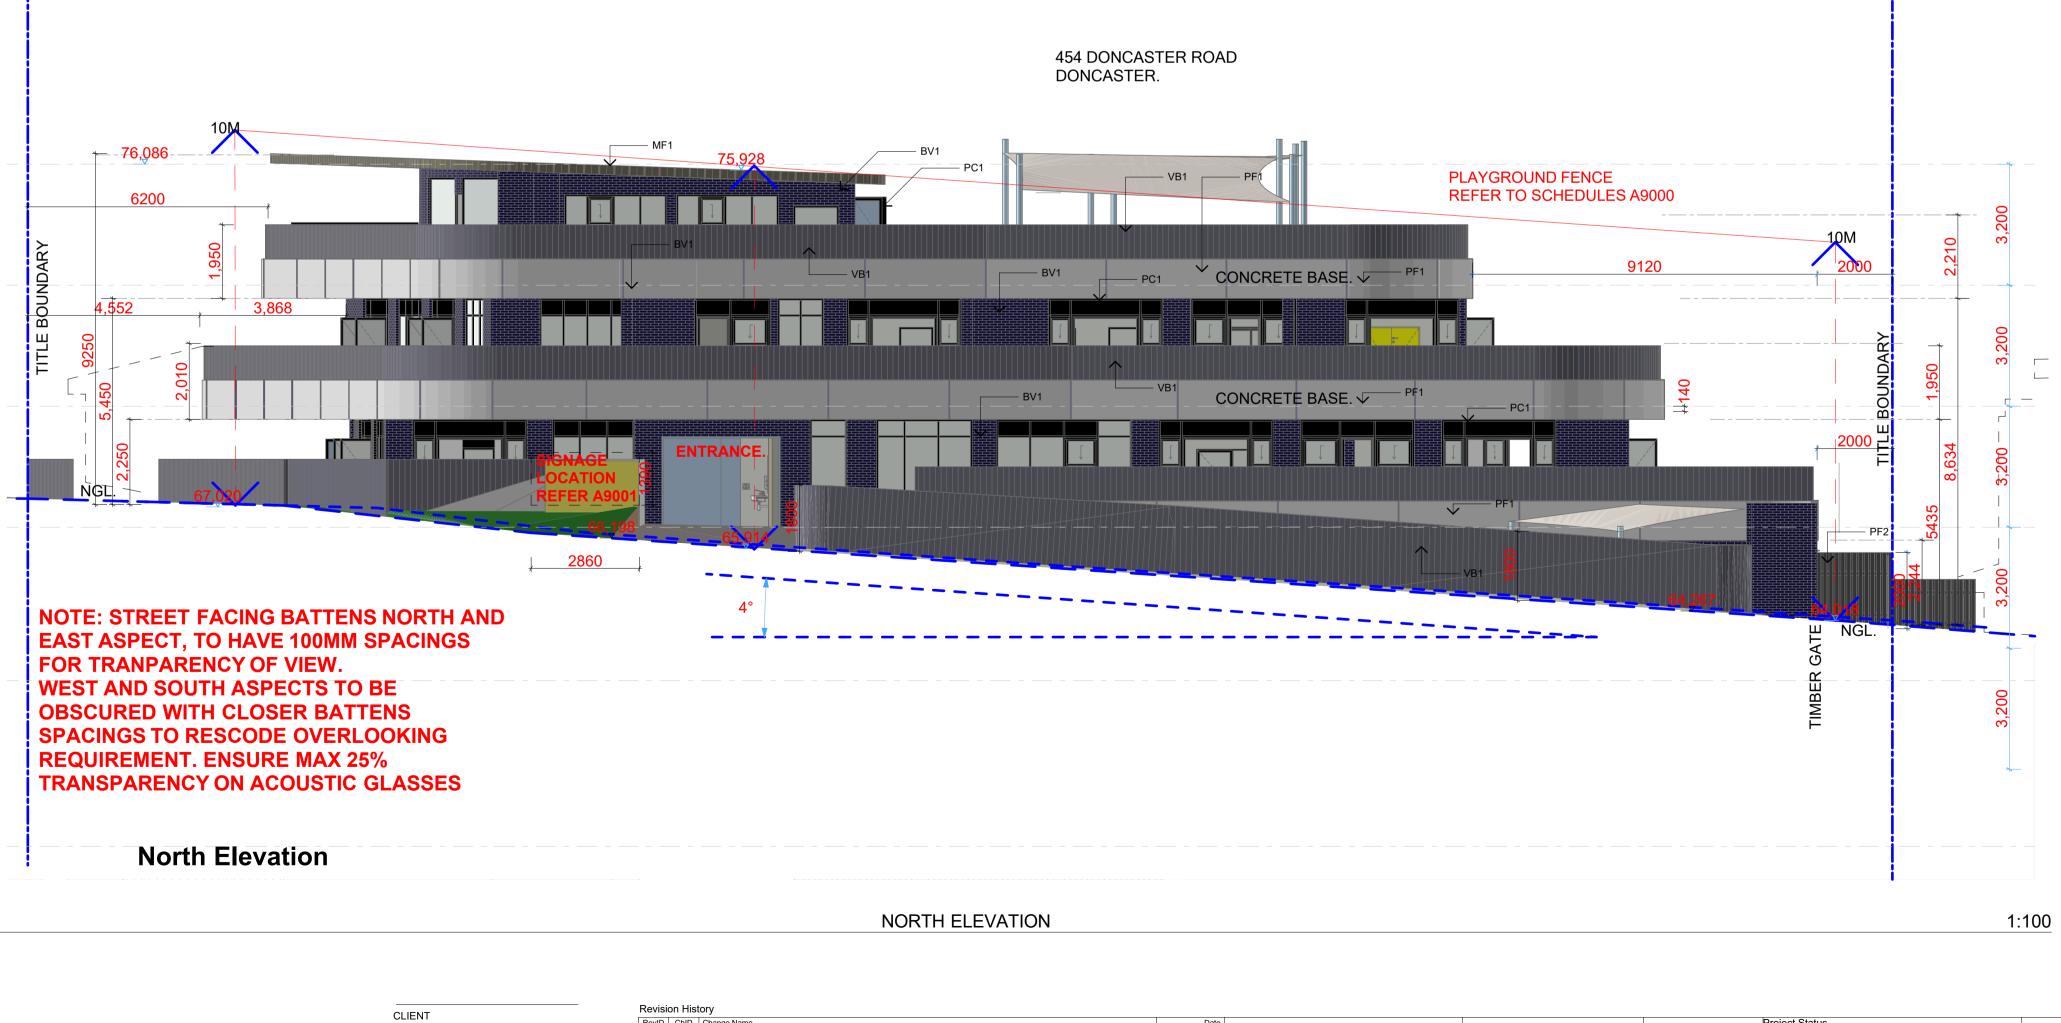

KANE BARNETT

 Revision History

 ReviD
 ChID
 Change Name

 01

 01

 01

 02

 02

Date				Project Status	
14/03/2018		Modified by	Date		Drawing Name
22/11/2018		DE	28/06/2019		ELEVATION
3/12/2018					ELEVATION
28/06/2019	Drawing Scale	Checked by	Date	TOWN PLANNING	
	1.100 @01	5			
	1.100 @AT	DE	28/06/2019		
28/06/2019	Drawing Scale 1:100 @A1	Checked by DE	Date 28/06/2019	TOWN PLANNING	



BV1 BRICKS BLUE METALLIC

PC 1 POWDERCOAT BLACK

> PF 1 CCS FINISH RAFIA BEIGE

PF 2 PAINT FINISH IRONSTONE

VB1 VERTICAL BATTEN & ACOUSTIC GLASS / ACRYLIC

MF1 METAL FINISH CLOURBOND IRONSTONE




2/21 Waterloo Road. Collingwood PH: 0425756708 EMAIL admin@colabarchitects.com.au ABN: 97 150 968 497





South Elevation

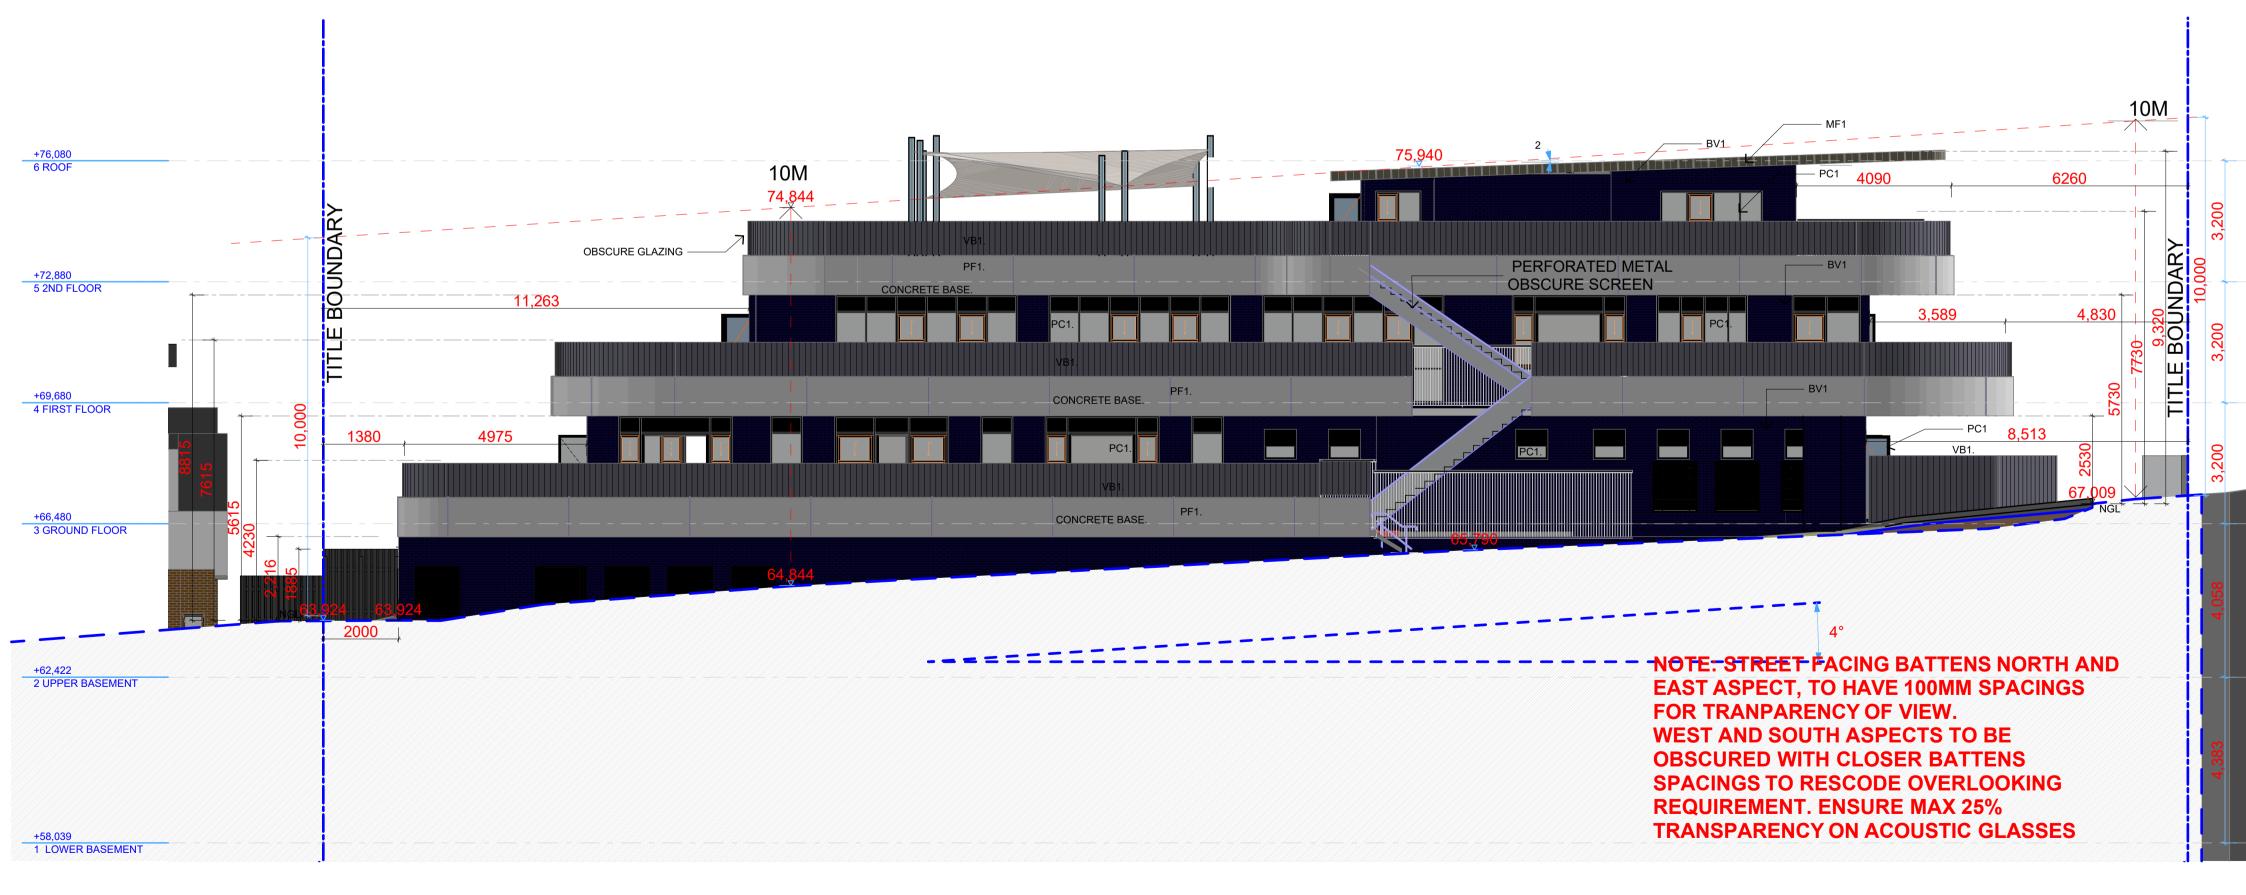

E-02

CLIENT

KANE BARNETT

	Revisi	on Hist	ory
[RevID	ChID	Change Name
	0		
	1		
	2		

SOUTH ELEVATION

Date				Project Status	
22/11/2018		Modified by	Date		Drawing Name
3/12/2018		DE	28/06/2019		ELEVATION
28/06/2019					ELEVATION
	Drawing Scale	Checked by	Date	TOWN PLANNING	
	1:100 @A1				
 	1.100 @AI	DE	28/06/2019		

2/21 Waterloo Road. Collingwood PH: 0425756708 EMAIL admin@colabarchitects.com.au ABN: 97 150 968 497

SITE ADRESS 454 Doncaster Road Doncaster Victoria Australia

A3001 A 4

PAINT FINISH IRONSTONE VB1 VERTICAL

BATTEN & ACOUSTIC GLASS / ACRYLIC

MF1

METAL FINISH

CLOURBOND IRONSTONE

RAFIA BEIGE PF 2

CCS FINISH

PC 1 **POWDERCOAT BLACK PF 1**

BV1 BRICKS **BLUE METALLIC**

+76,080 6 ROOF

+72,880 5 2ND FLOOR

+69,680 4 FIRST FLOOR

+66,480 3 GROUND FLOOR

+62,422 2 UPPER BASEMENT

+58,039 1 LOWER BASEMENT

1:100

ARCHITECTURE

lab





CLIENT	Revision History				
GEIEINT	RevID	ChID	Change Name		
	0				
	1				
	2				
KANE BARNETT					



BV1 BRICKS **BLUE METALLIC**

PC 1 **POWDERCOAT BLACK**

> PF 1 **CCS FINISH RAFIA BEIGE**

PF 2 **PAINT FINISH** IRONSTONE

VB1 VERTICAL **BATTEN & ACOUSTIC** GLASS / ACRYLIC

MF1 **METAL FINISH CLOURBOND IRONSTONE**

NOTE: STREET FACING BATTENS NORTH AND EAST ASPECT, TO HAVE 100MM SPACINGS FOR TRANPARENCY OF VIEW. WEST AND SOUTH ASPECTS TO BE **OBSCURED WITH CLOSER BATTENS** SPACINGS TO RESCODE OVERLOOKING **REQUIREMENT. ENSURE MAX 25%** TRANSPARENCY ON ACOUSTIC GLASSES

NOTE:OVER LOOKING AND ANTICLIMBING **OBSCURED PERFORATED SCREEN** TO INSIDE OF PERIMETER WALLS. PLEASE REFER TO TYPICAL **DETAIL DRAWING AND FINISHES IN SCHEDULES SHEET NO.A9000**

1:100

	Date				Project Status	
	22/11/2018		Modified by	Date		Drawing Name
	3/12/2018		DE	28/06/2019		ELEVATION
	28/06/2019					ELEVATION
		Drawing Scale			TOWN PLANNING	
		4.400 @44	Checked by	Date		
		1:100 @A1	DE	28/06/2019		
I		_	1	I		






2/21 Waterloo Road. Collingwood PH: 0425756708 EMAIL admin@colabarchitects.com.au ABN: 97 150 968 497





West Elevation

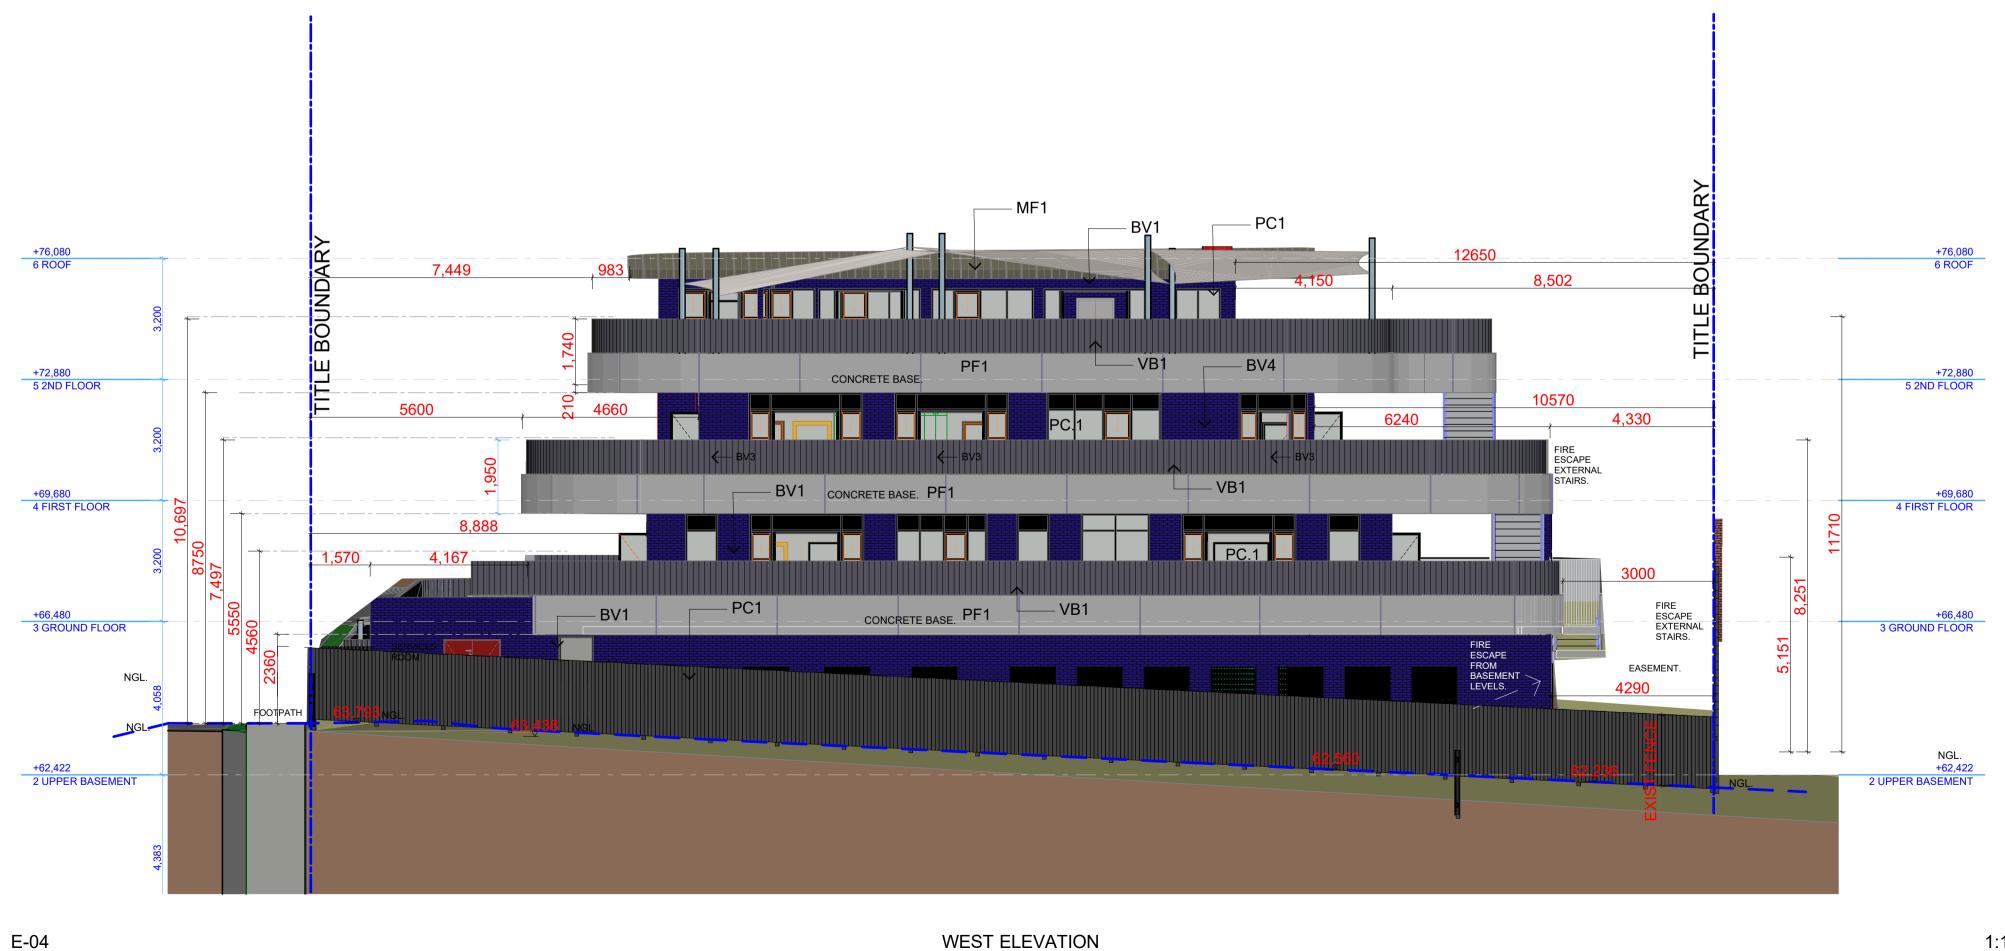

WEST ELEVATION

CLIENT

KANE BARNETT



BV1 BRICKS **BLUE METALLIC**

PC 1 **POWDERCOAT BLACK**

> PF 1 **CCS FINISH RAFIA BEIGE**

PF 2 PAINT FINISH IRONSTONE

VB1 VERTICAL **BATTEN & ACOUSTIC GLASS / ACRYLIC**

MF1 **METAL FINISH CLOURBOND IRONSTONE**

NOTE: STREET FACING BATTENS NORTH AND EAST ASPECT, TO HAVE 100MM SPACINGS FOR TRANPARENCY OF VIEW. WEST AND SOUTH ASPECTS TO BE **OBSCURED WITH CLOSER BATTENS** SPACINGS TO RESCODE OVERLOOKING **REQUIREMENT. ENSURE MAX 25% TRANSPARENCY ON ACOUSTIC GLASSES**

NOTE:OVER LOOKING AND ANTICLIMBING OBSCURED PERFORATED SCREEN TO INSIDE OF PERIMETER WALLS. PLEASE REFER TO TYPICAL **DETAIL DRAWING AND FINISHES IN SCHEDULES SHEET NO.A9000**

1:100

Date 14/03/2018 22/11/2018 3/12/2018		Modified by DE	Date 28/06/2019	Project Status	Drawing Name: ELEVATION
	Drawing Scale 1:100 @A1	Checked by DE	Date 28/06/2019	TOWN PLANNING	



2/21 Waterloo Road. Collingwood PH: 0425756708 EMAIL admin@colabarchitects.com.au ABN: 97 150 968 497





North Elevation



Revision History						
RevID	ChID	Change Name				
0						
1						
2						

CLIENT

KANE BARNETT

Date				Project Status	
22/11/2018		Modified by	Date		Drawing Name
3/12/2018		DE	28/06/2019		ELEVATIONS STREETSCAPE
28/06/2019					ELEVATIONS STREETSCAPE
	Drawing Scale	Checked by	Date	TOWN PLANNING	
	1:200 @A1	DE	28/06/2019		
		DE	20/00/2019		



BV1 BRICKS **BLUE METALLIC**

PC 1 **POWDERCOAT BLACK**

> **PF 1** CCS FINISH **RAFIA BEIGE**

PF 2 PAINT FINISH IRONSTONE

VB1 VERTICAL **BATTEN & ACOUSTIC** GLASS / ACRYLIC

MF1 **METAL FINISH CLOURBOND IRONSTONE**





NOTE: STREET FACING BATTENS NORTH AND EAST ASPECT, TO HAVE 100MM SPACINGS FOR TRANPARENCY OF VIEW. WEST AND SOUTH ASPECTS TO BE **OBSCURED WITH CLOSER BATTENS** SPACINGS TO RESCODE OVERLOOKING **REQUIREMENT. ENSURE MAX 25%** TRANSPARENCY ON ACOUSTIC GLASSES



2/21 Waterloo Road. Collingwood PH: 0425756708 EMAIL admin@colabarchitects.com.au ABN: 97 150 968 497



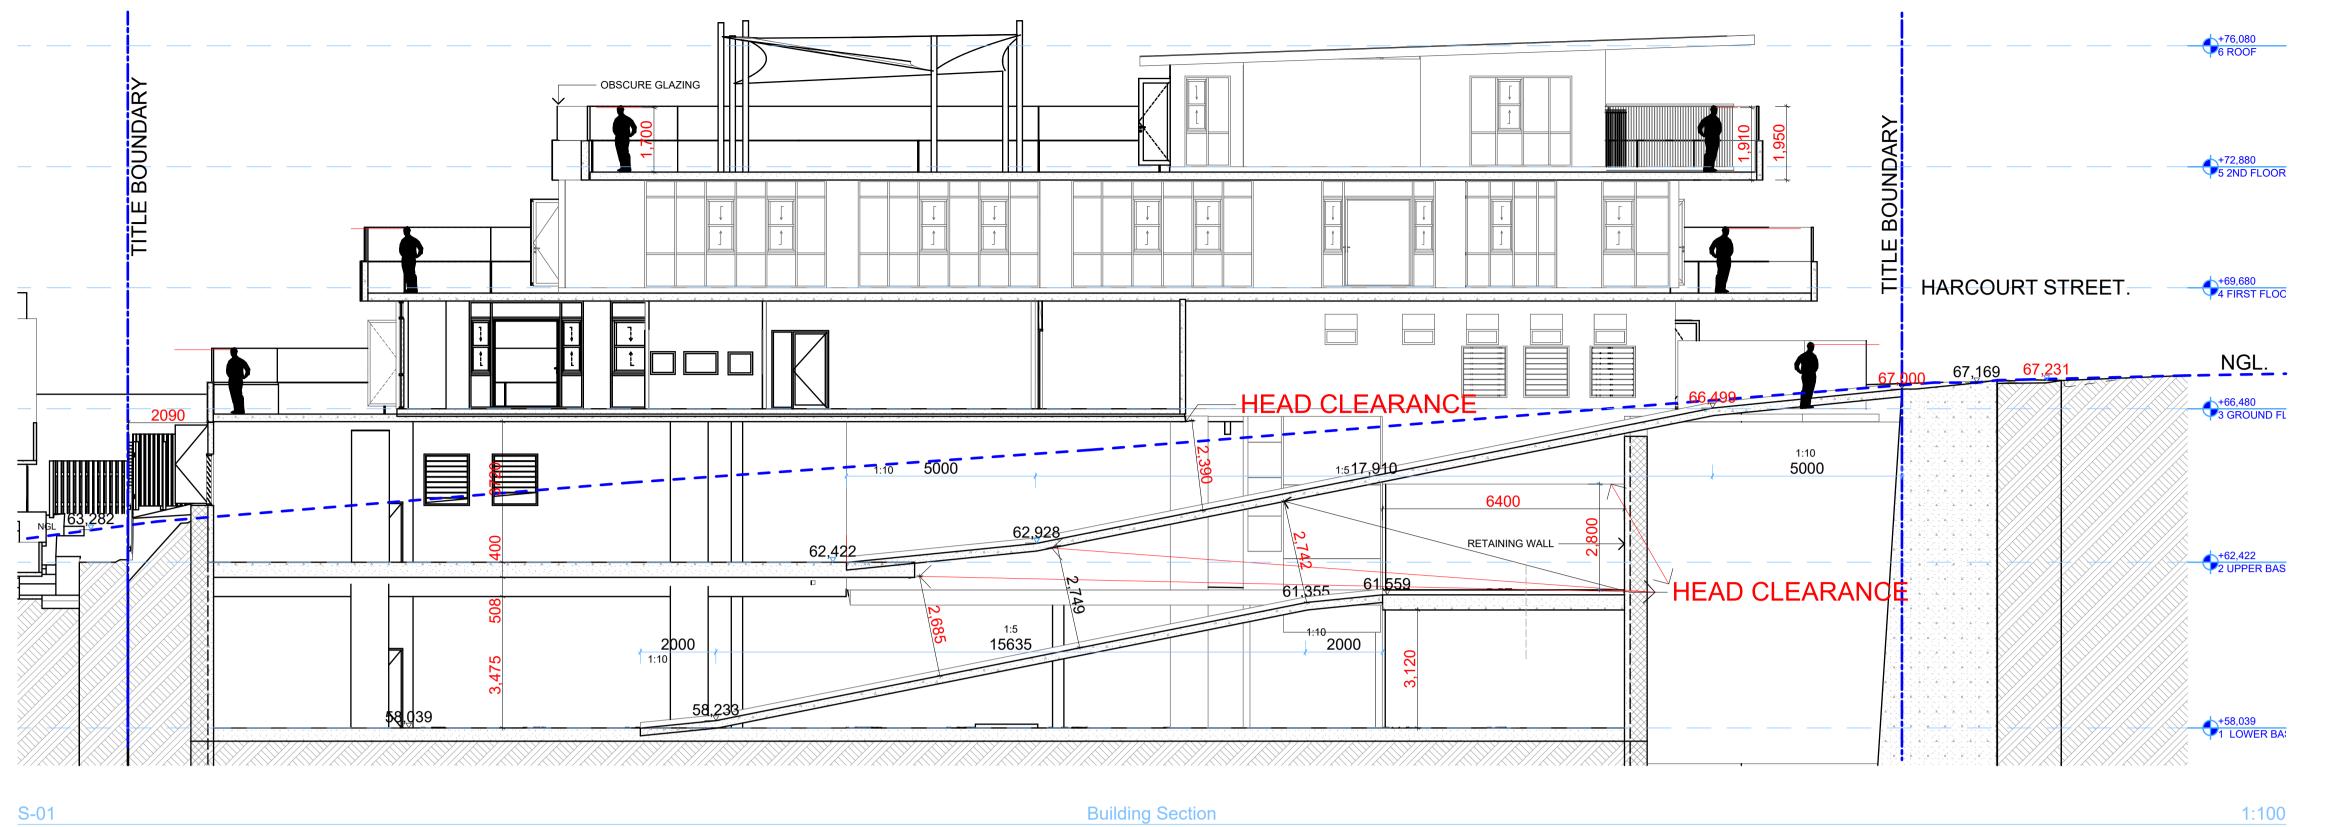

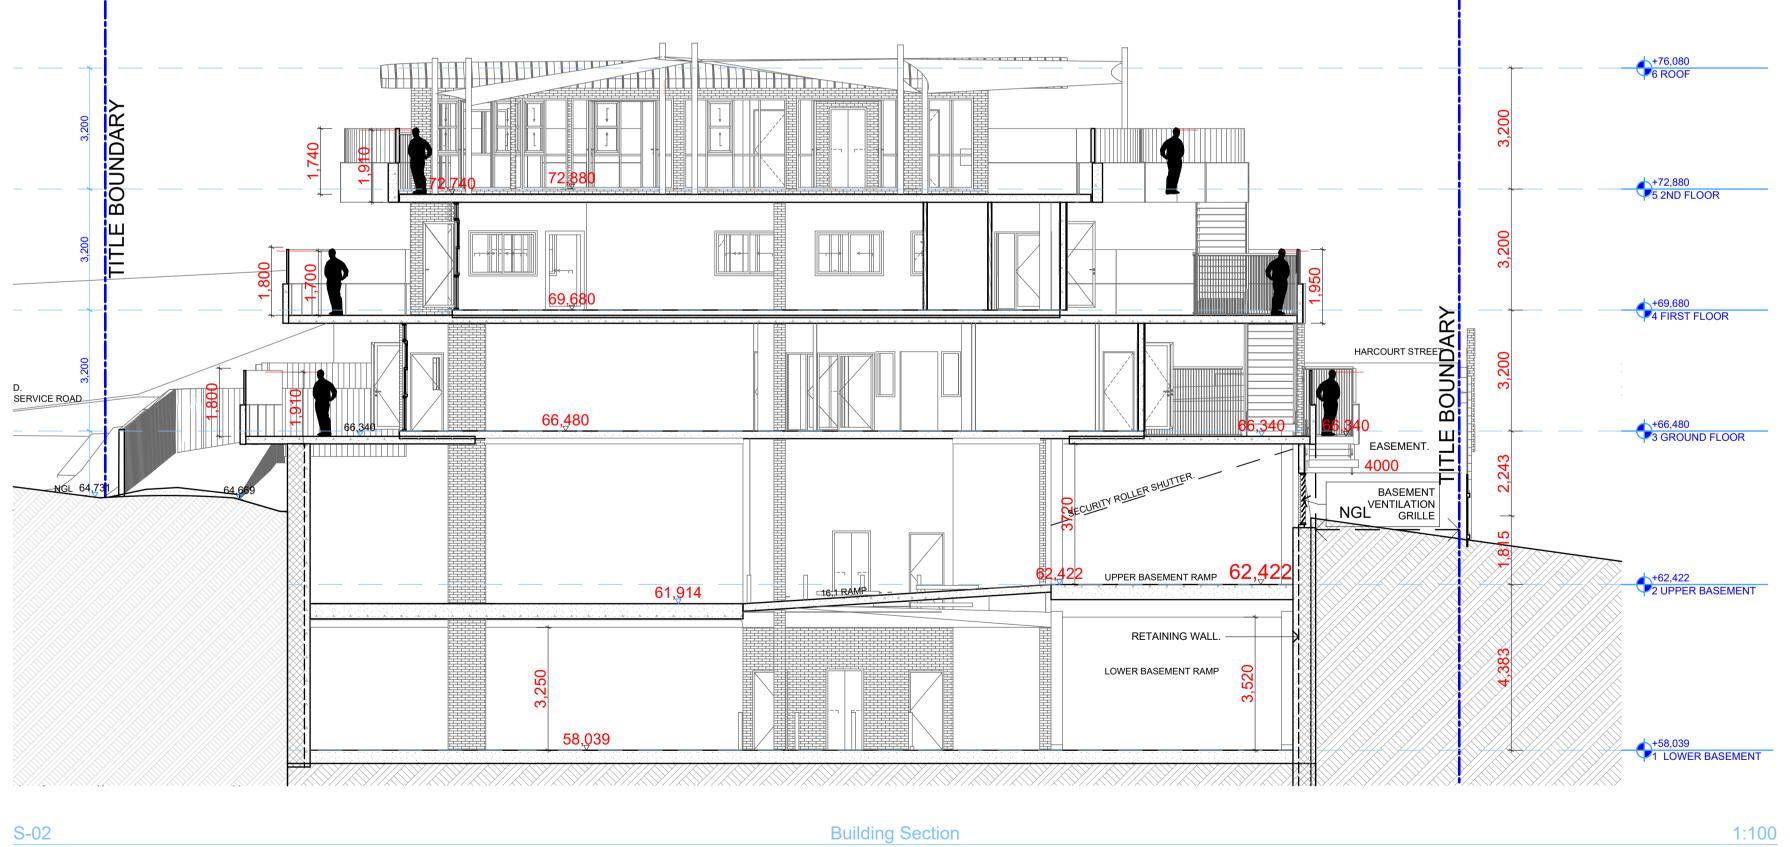

CLIENT

KANE BARNETT


	Revision History						
RevID	ChID	Change Name					
01							
0							
1							
02							


Date 14/03/2018 22/11/2018 3/12/2018	-	Modified by DE	Date 28/06/2019	Project Status	Drawing Name: SECTIONS
28/06/2019	Drawing Scale 1:100 @A1	Checked by DE	Date 28/06/2019	TOWN PLANNING	




2/21 Waterloo Road. Collingwood PH: 0425756708 EMAIL admin@colabarchitects.com.au ABN: 97 150 968 497



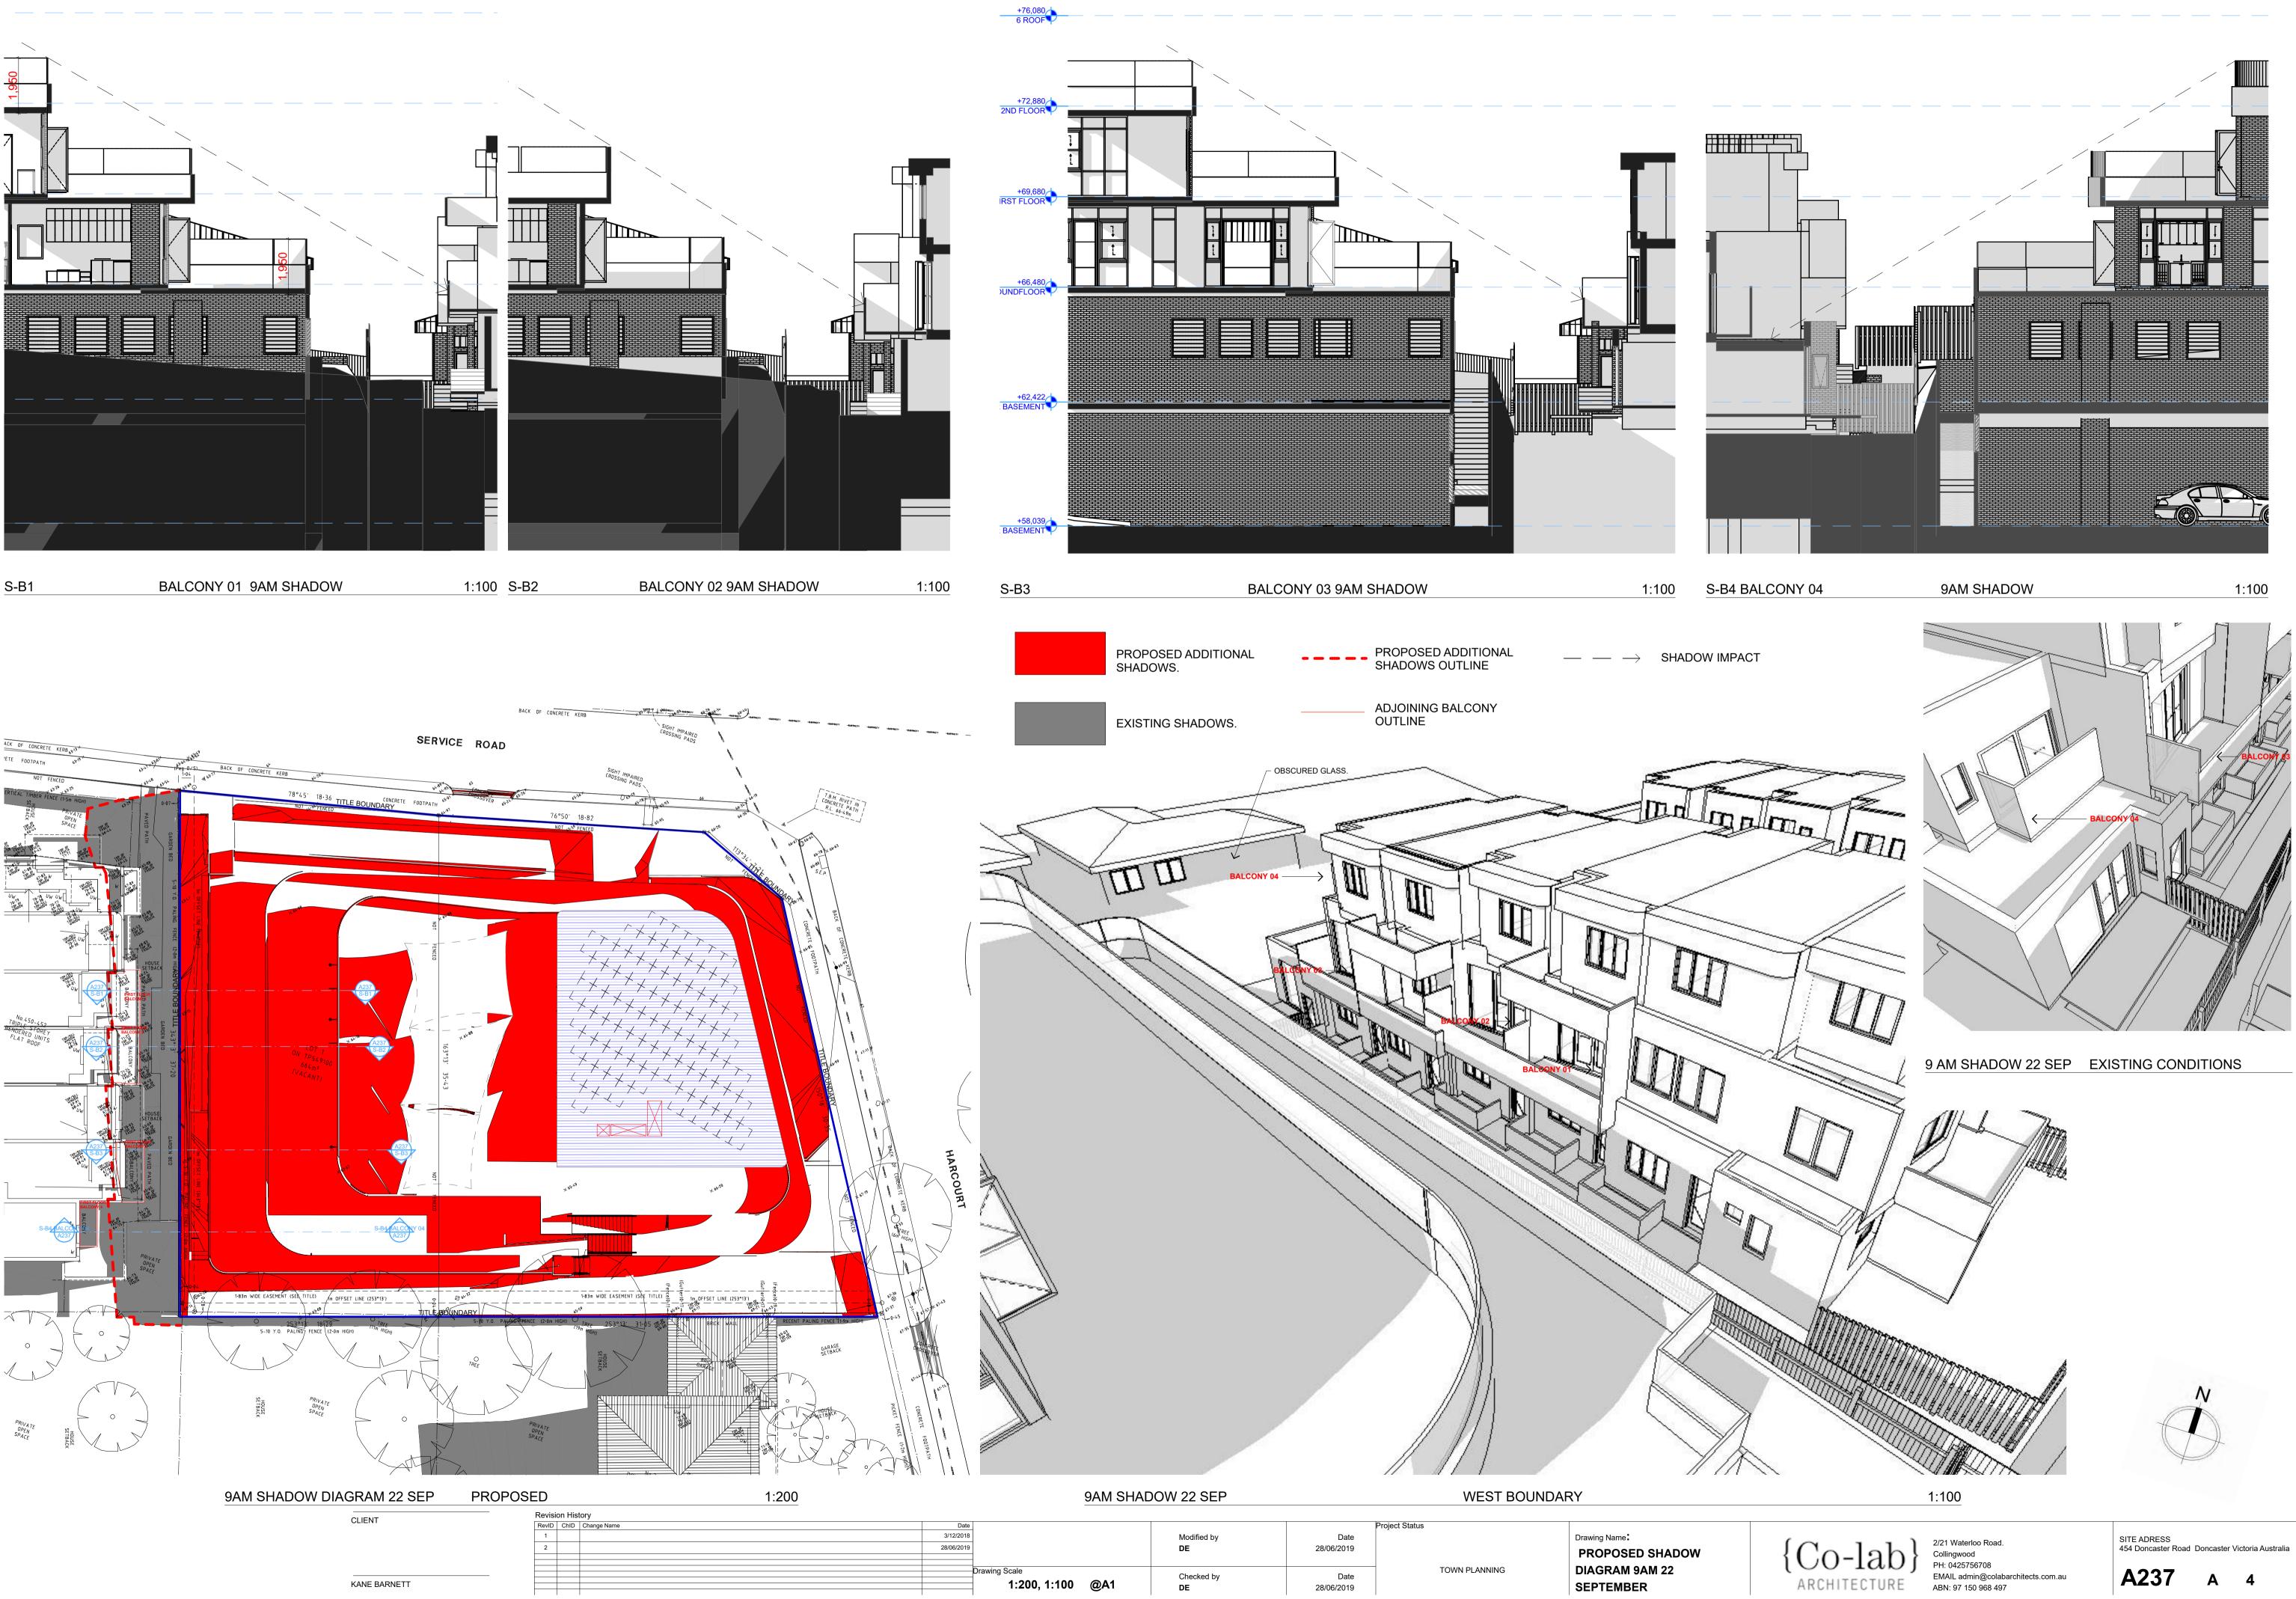

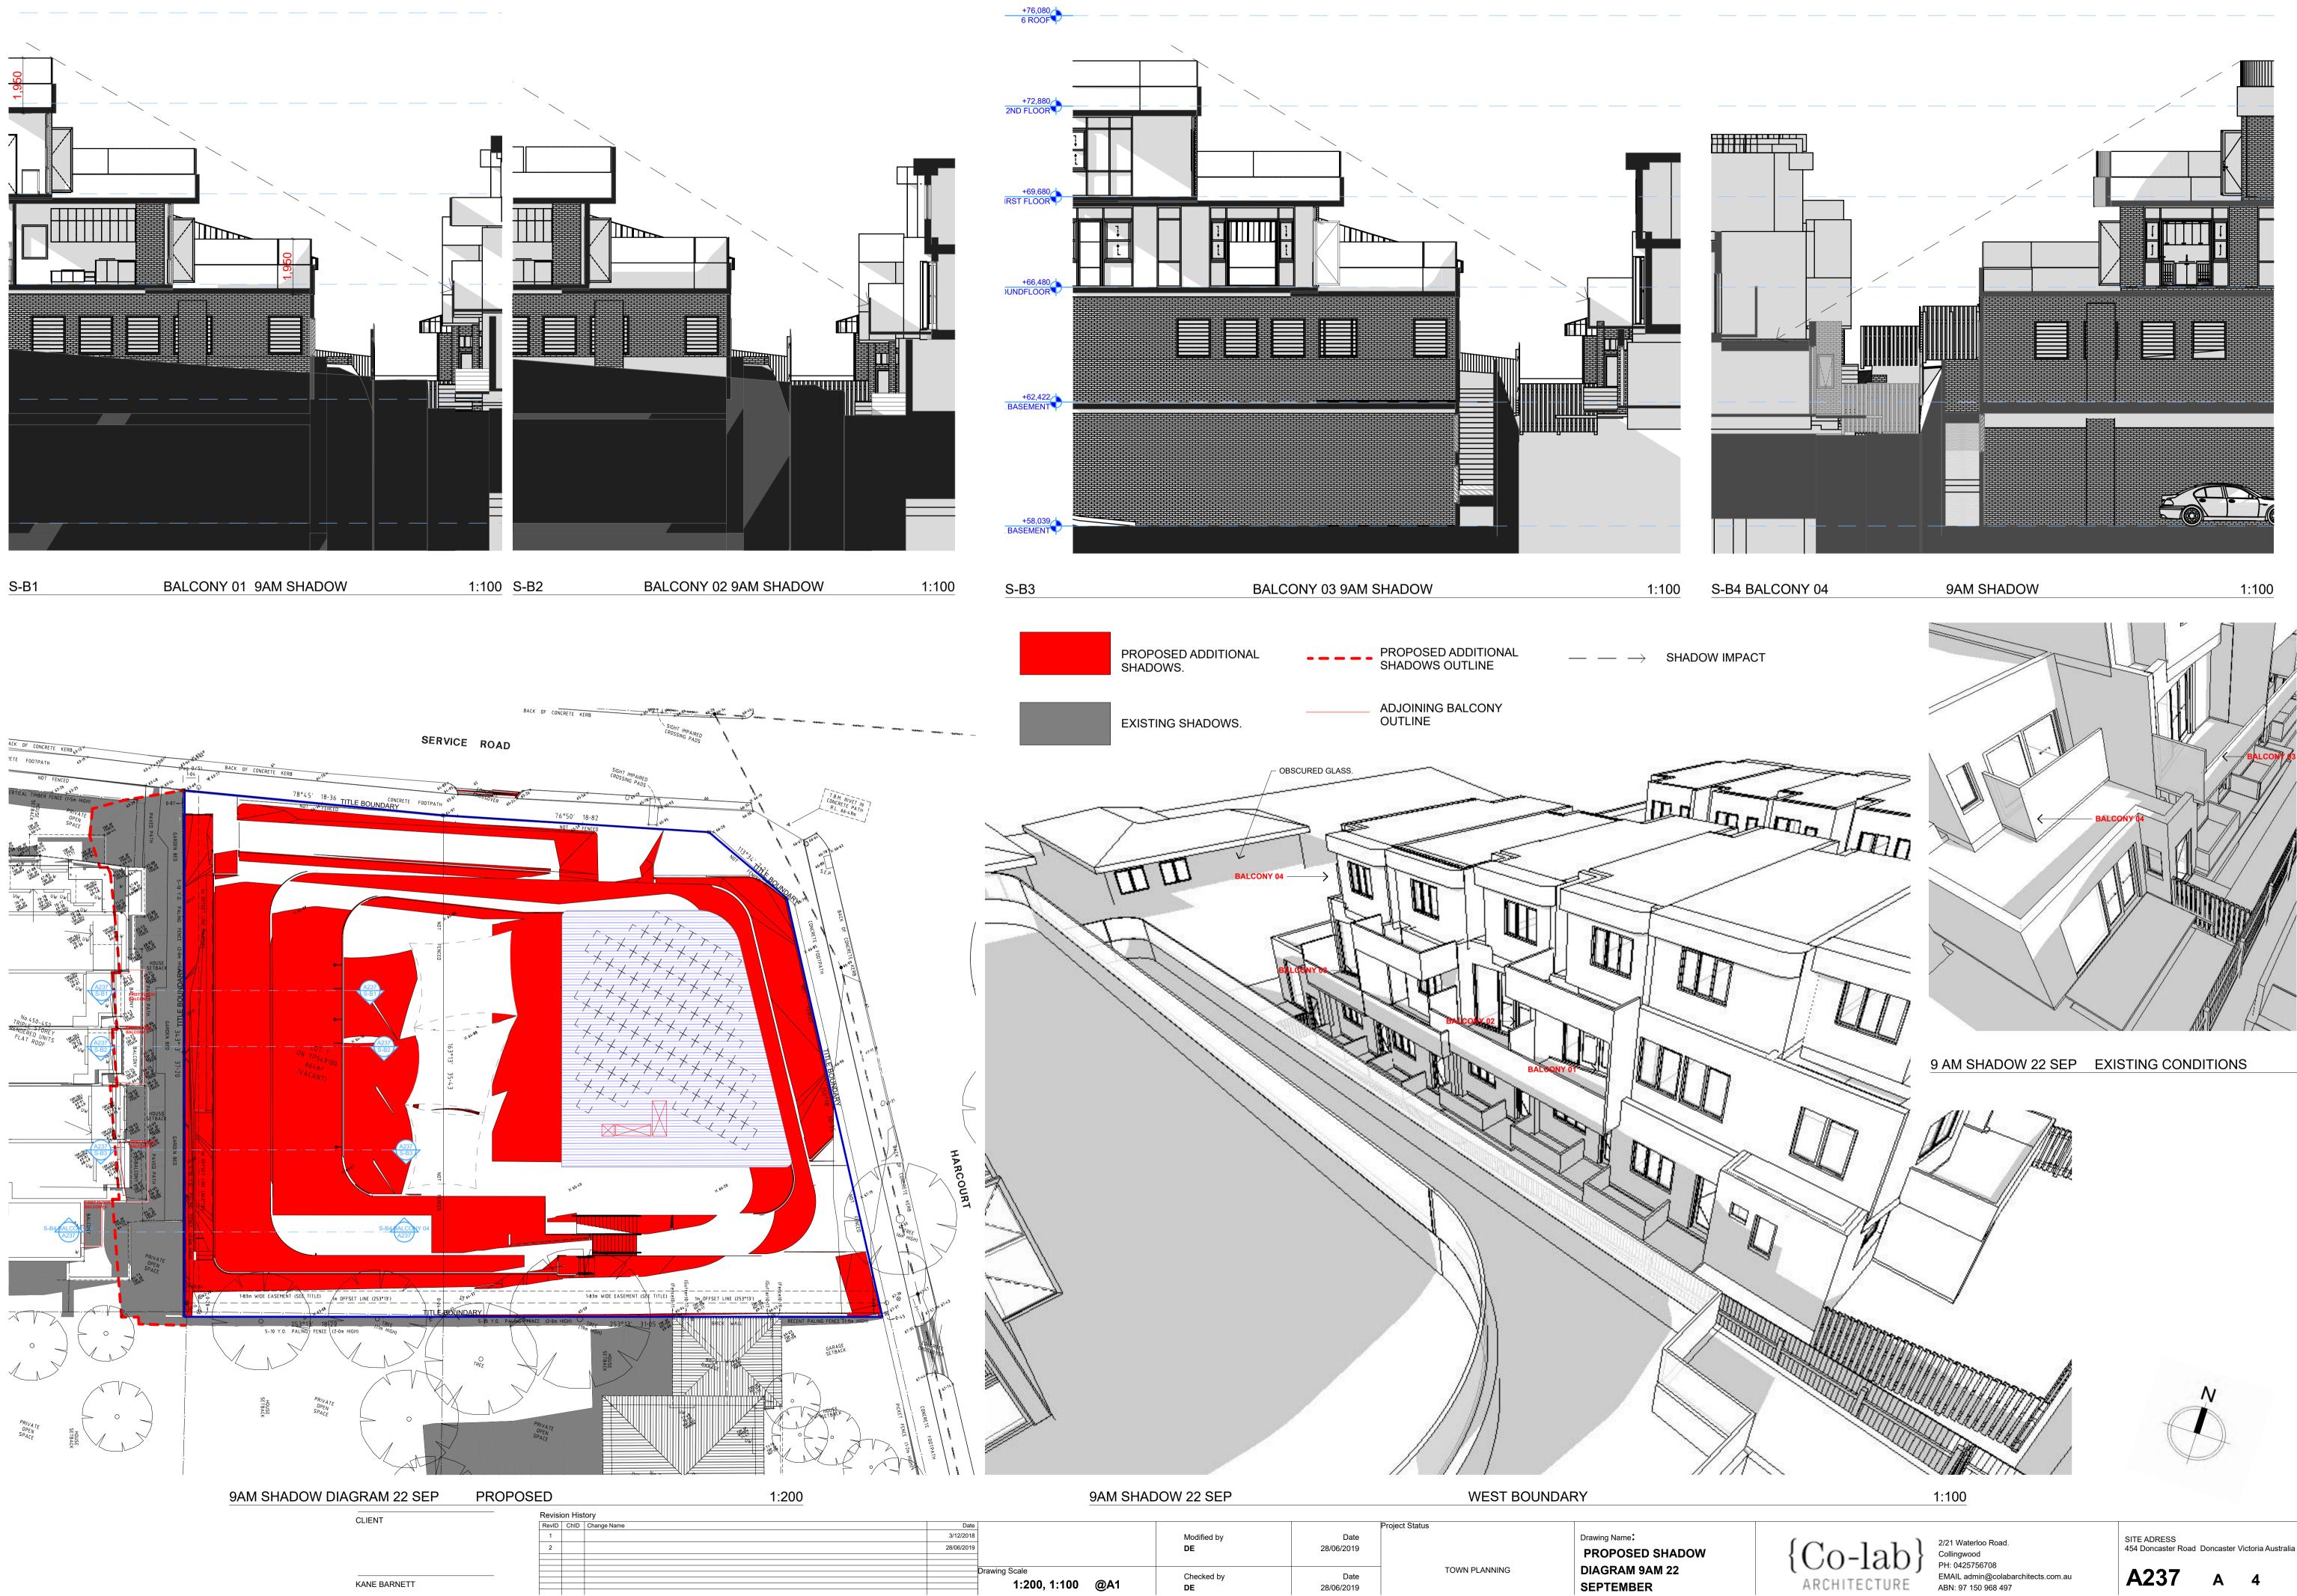


Date				Project Status	
3/12/2018		Modified by	Date		Drawing Name
28/06/2019		DE	28/06/2019		PROPOSED SHADOW
					PROPUSED SHADOW
	Drawing Scale			TOWN PLANNING	DIAGRAM 9AM 22
	Ŭ	Checked by	Date		
	1:200, 1:100 @A1	DE	28/06/2019		SEPTEMBER
		DE	20/00/2019		JEFTEWIDEN

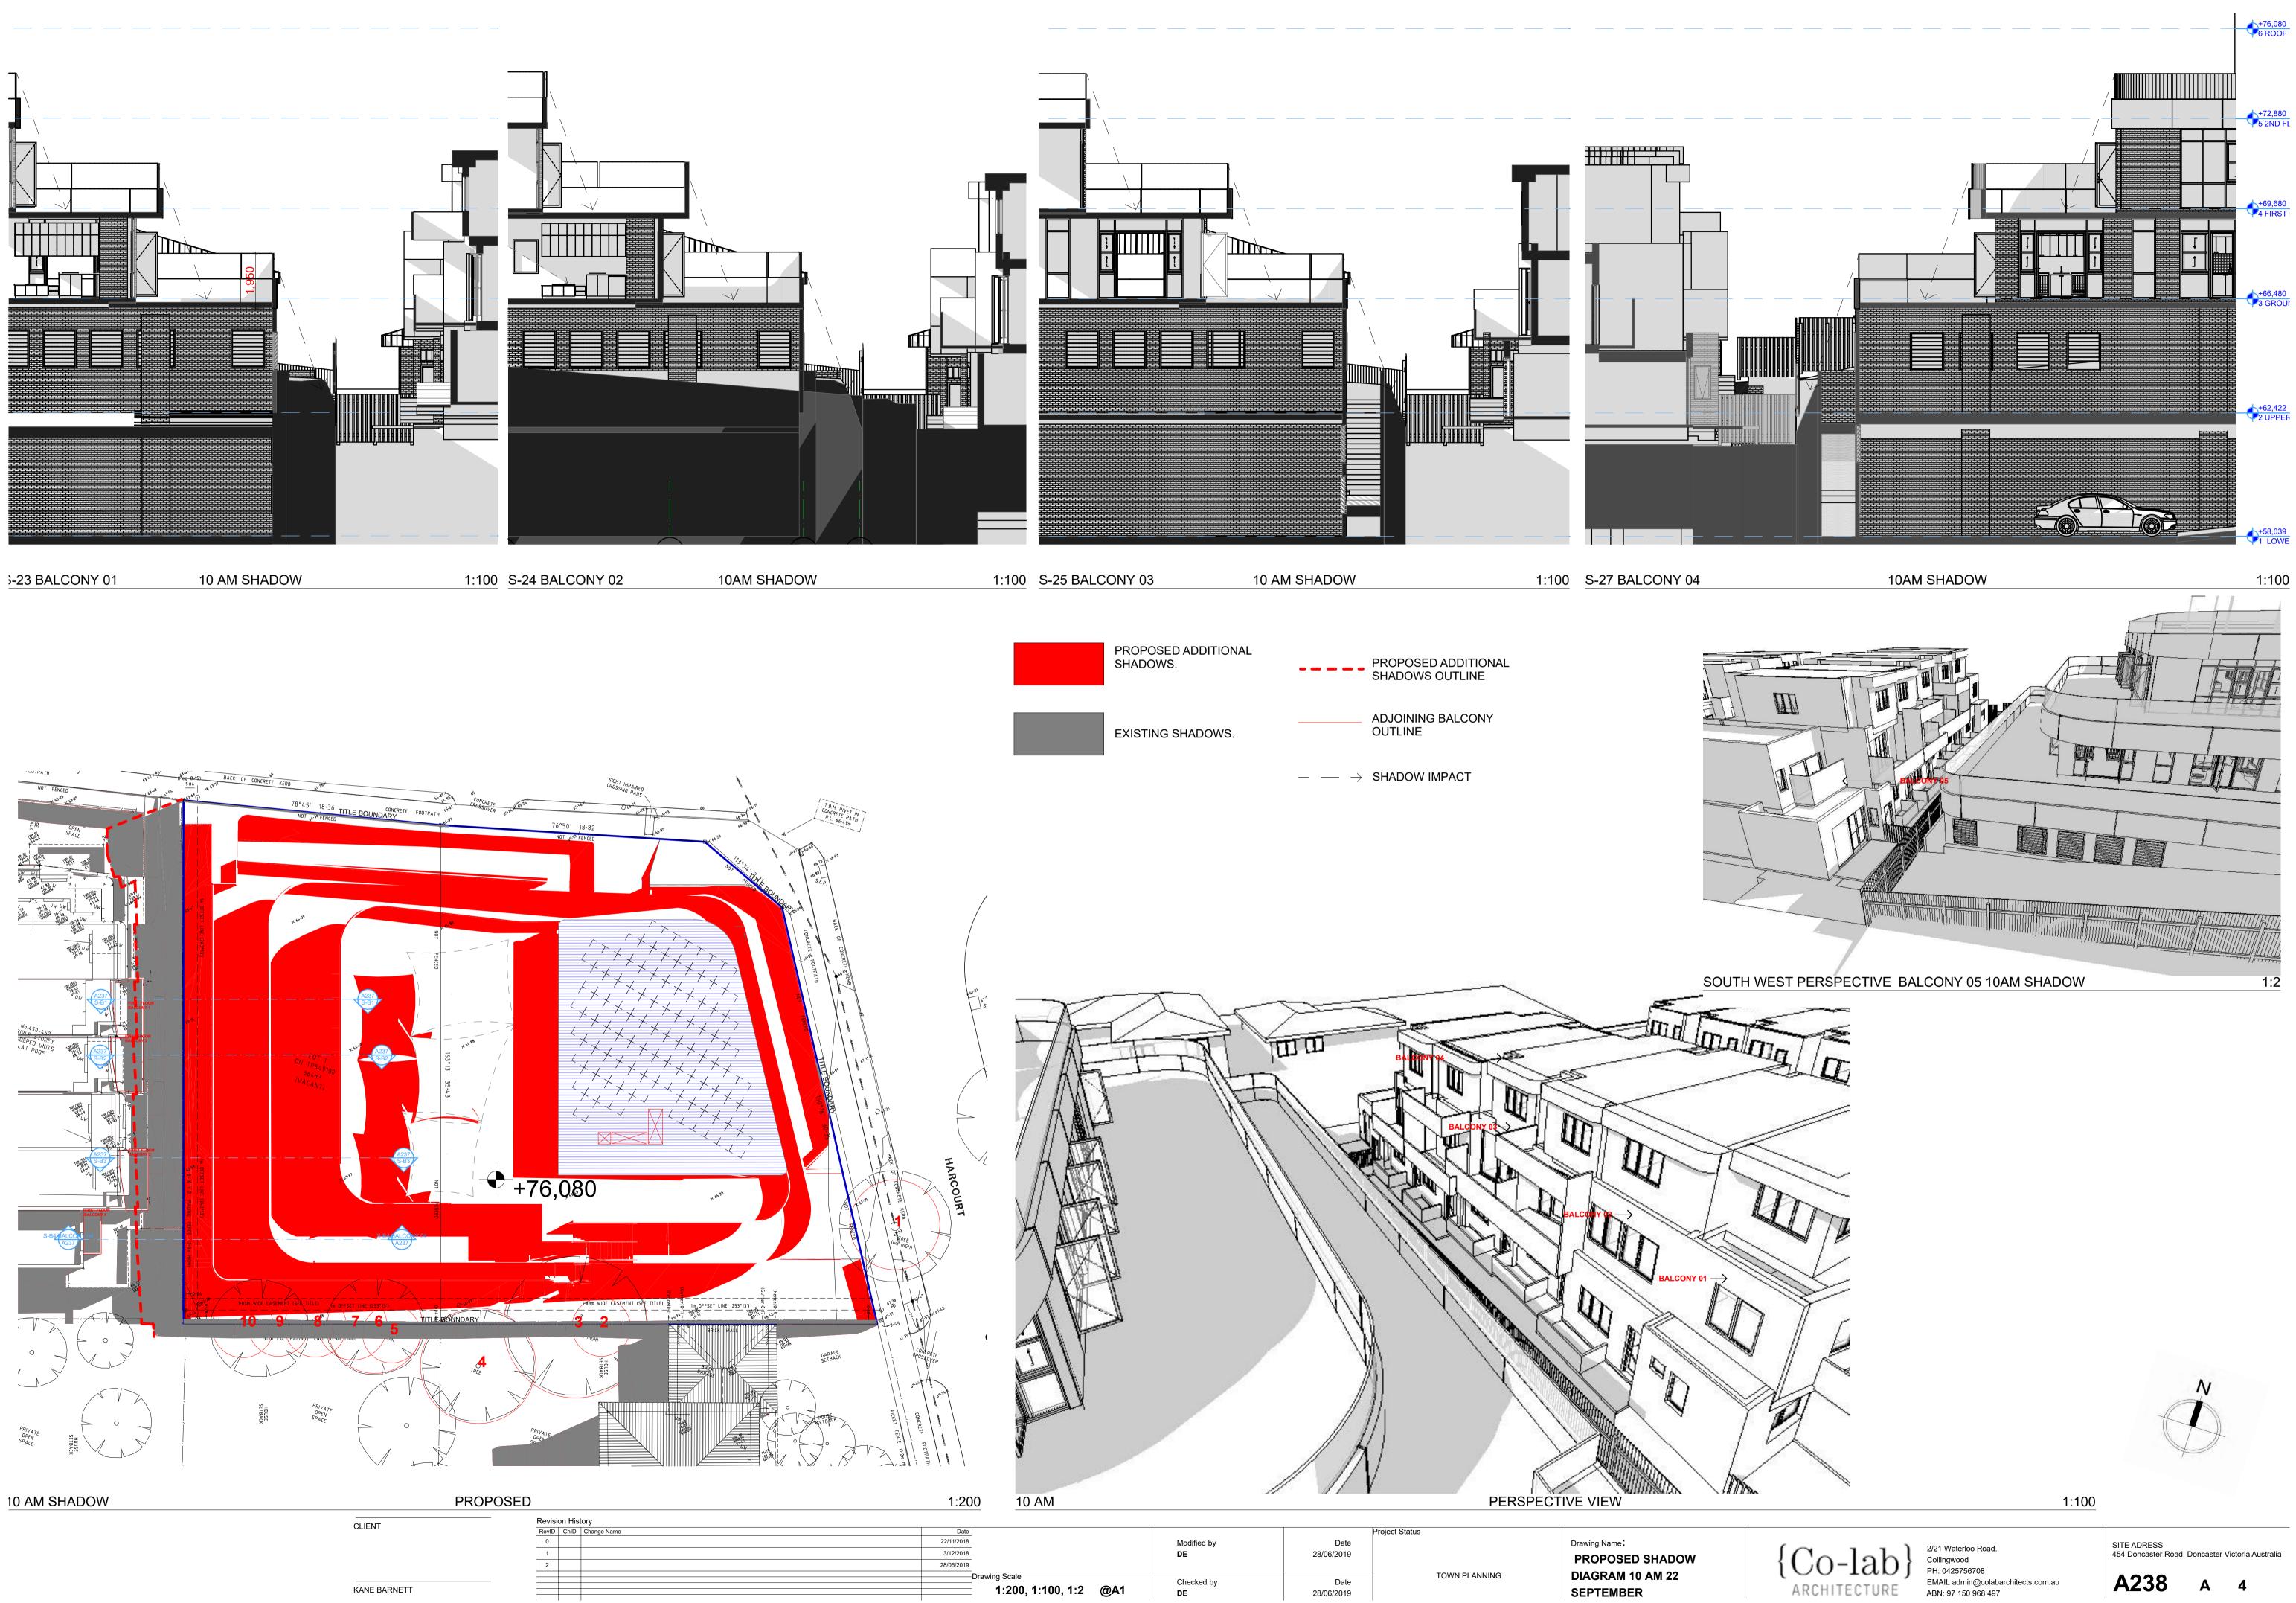






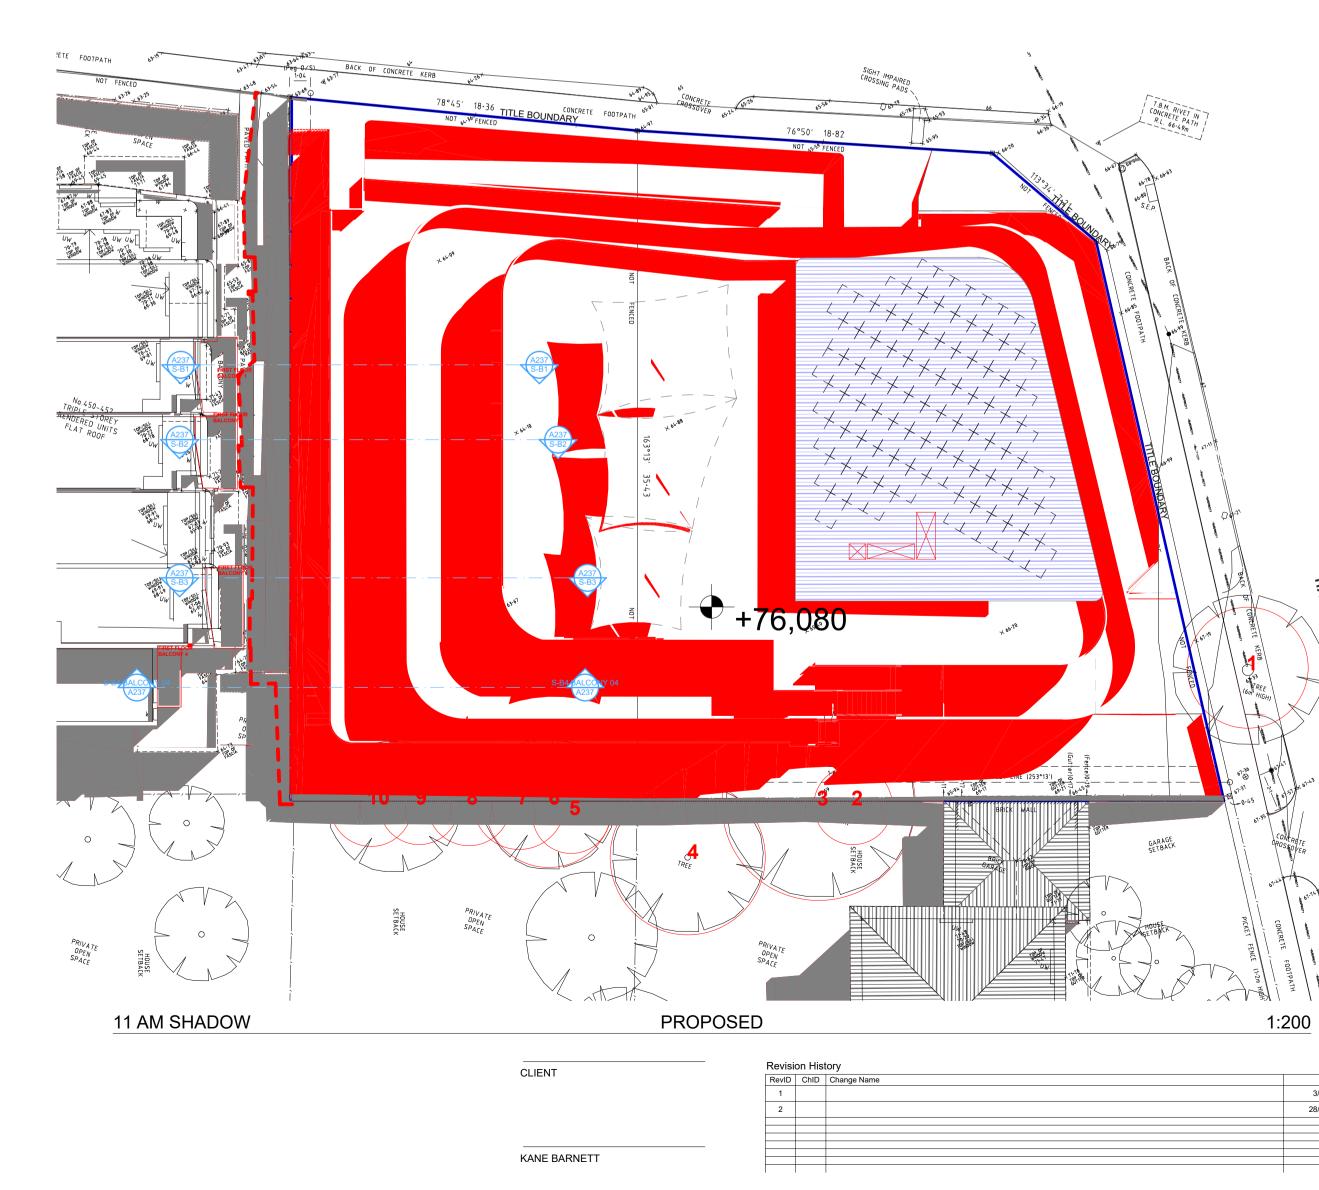





ROPOSED ADDITIONAL HADOWS.	PROPOSED ADDITIONAL SHADOWS OUTLINE	
KISTING SHADOWS.	ADJOINING BALCONY OUTLINE	




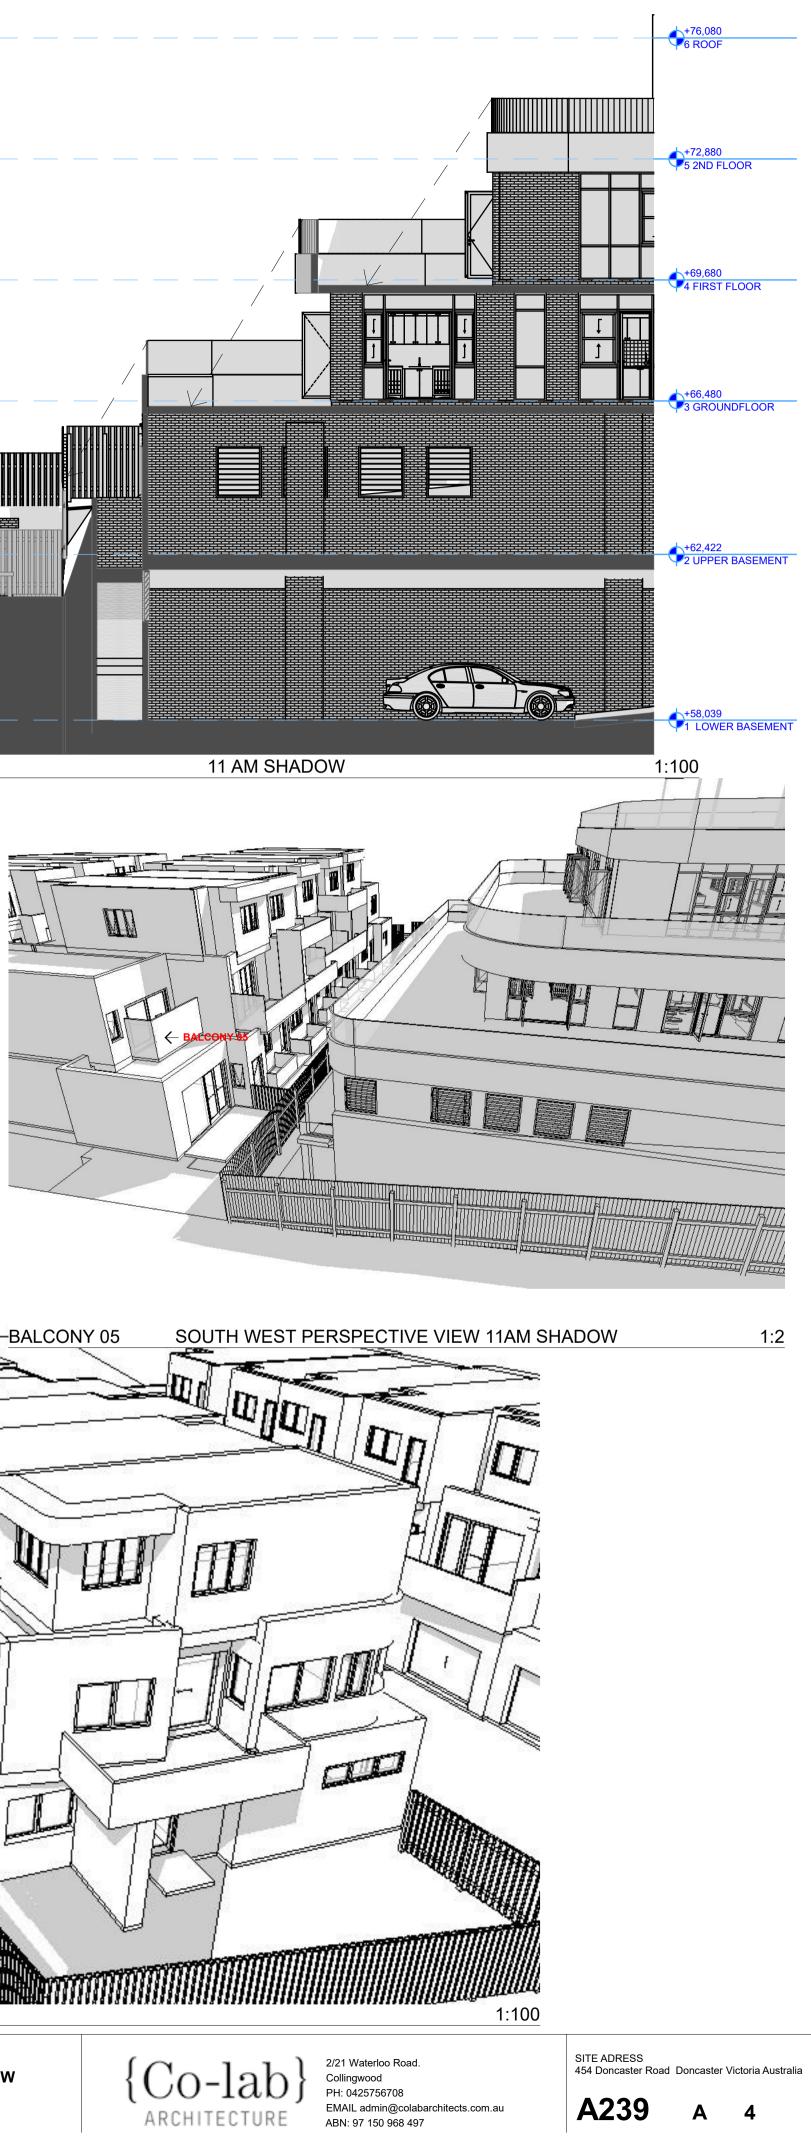

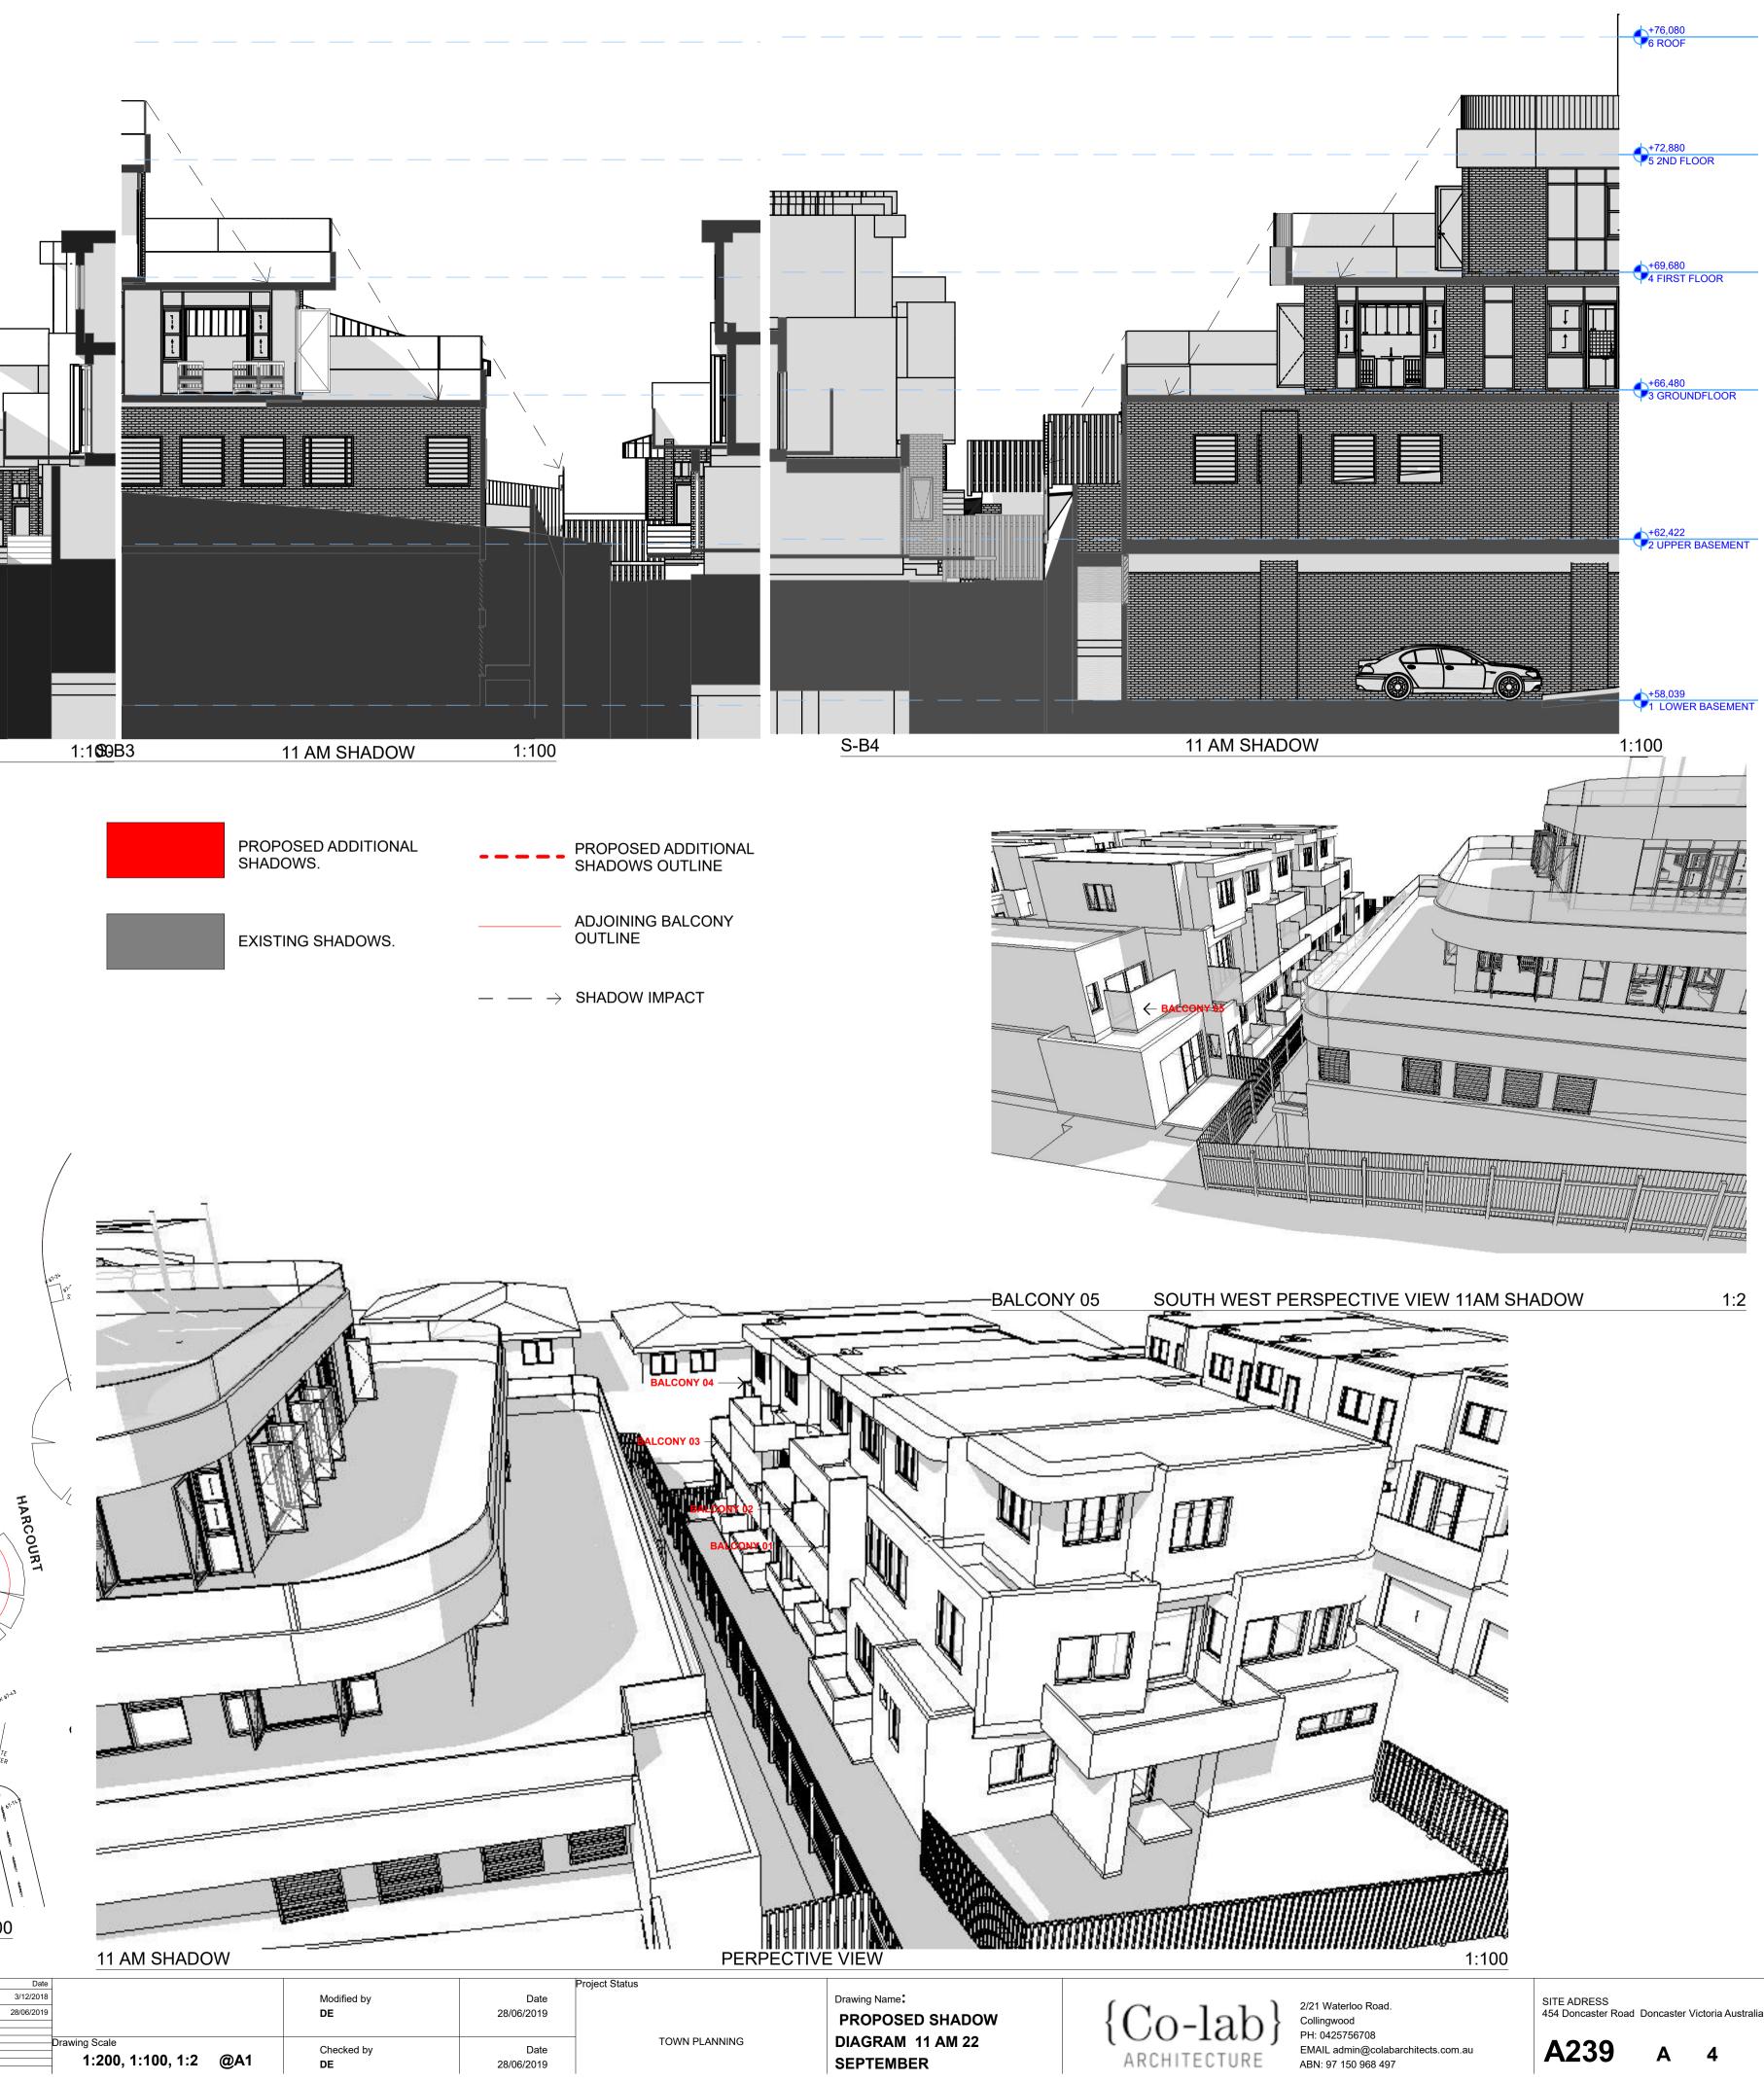

y Scale			
1:200,	1:100,	1:2	@A1

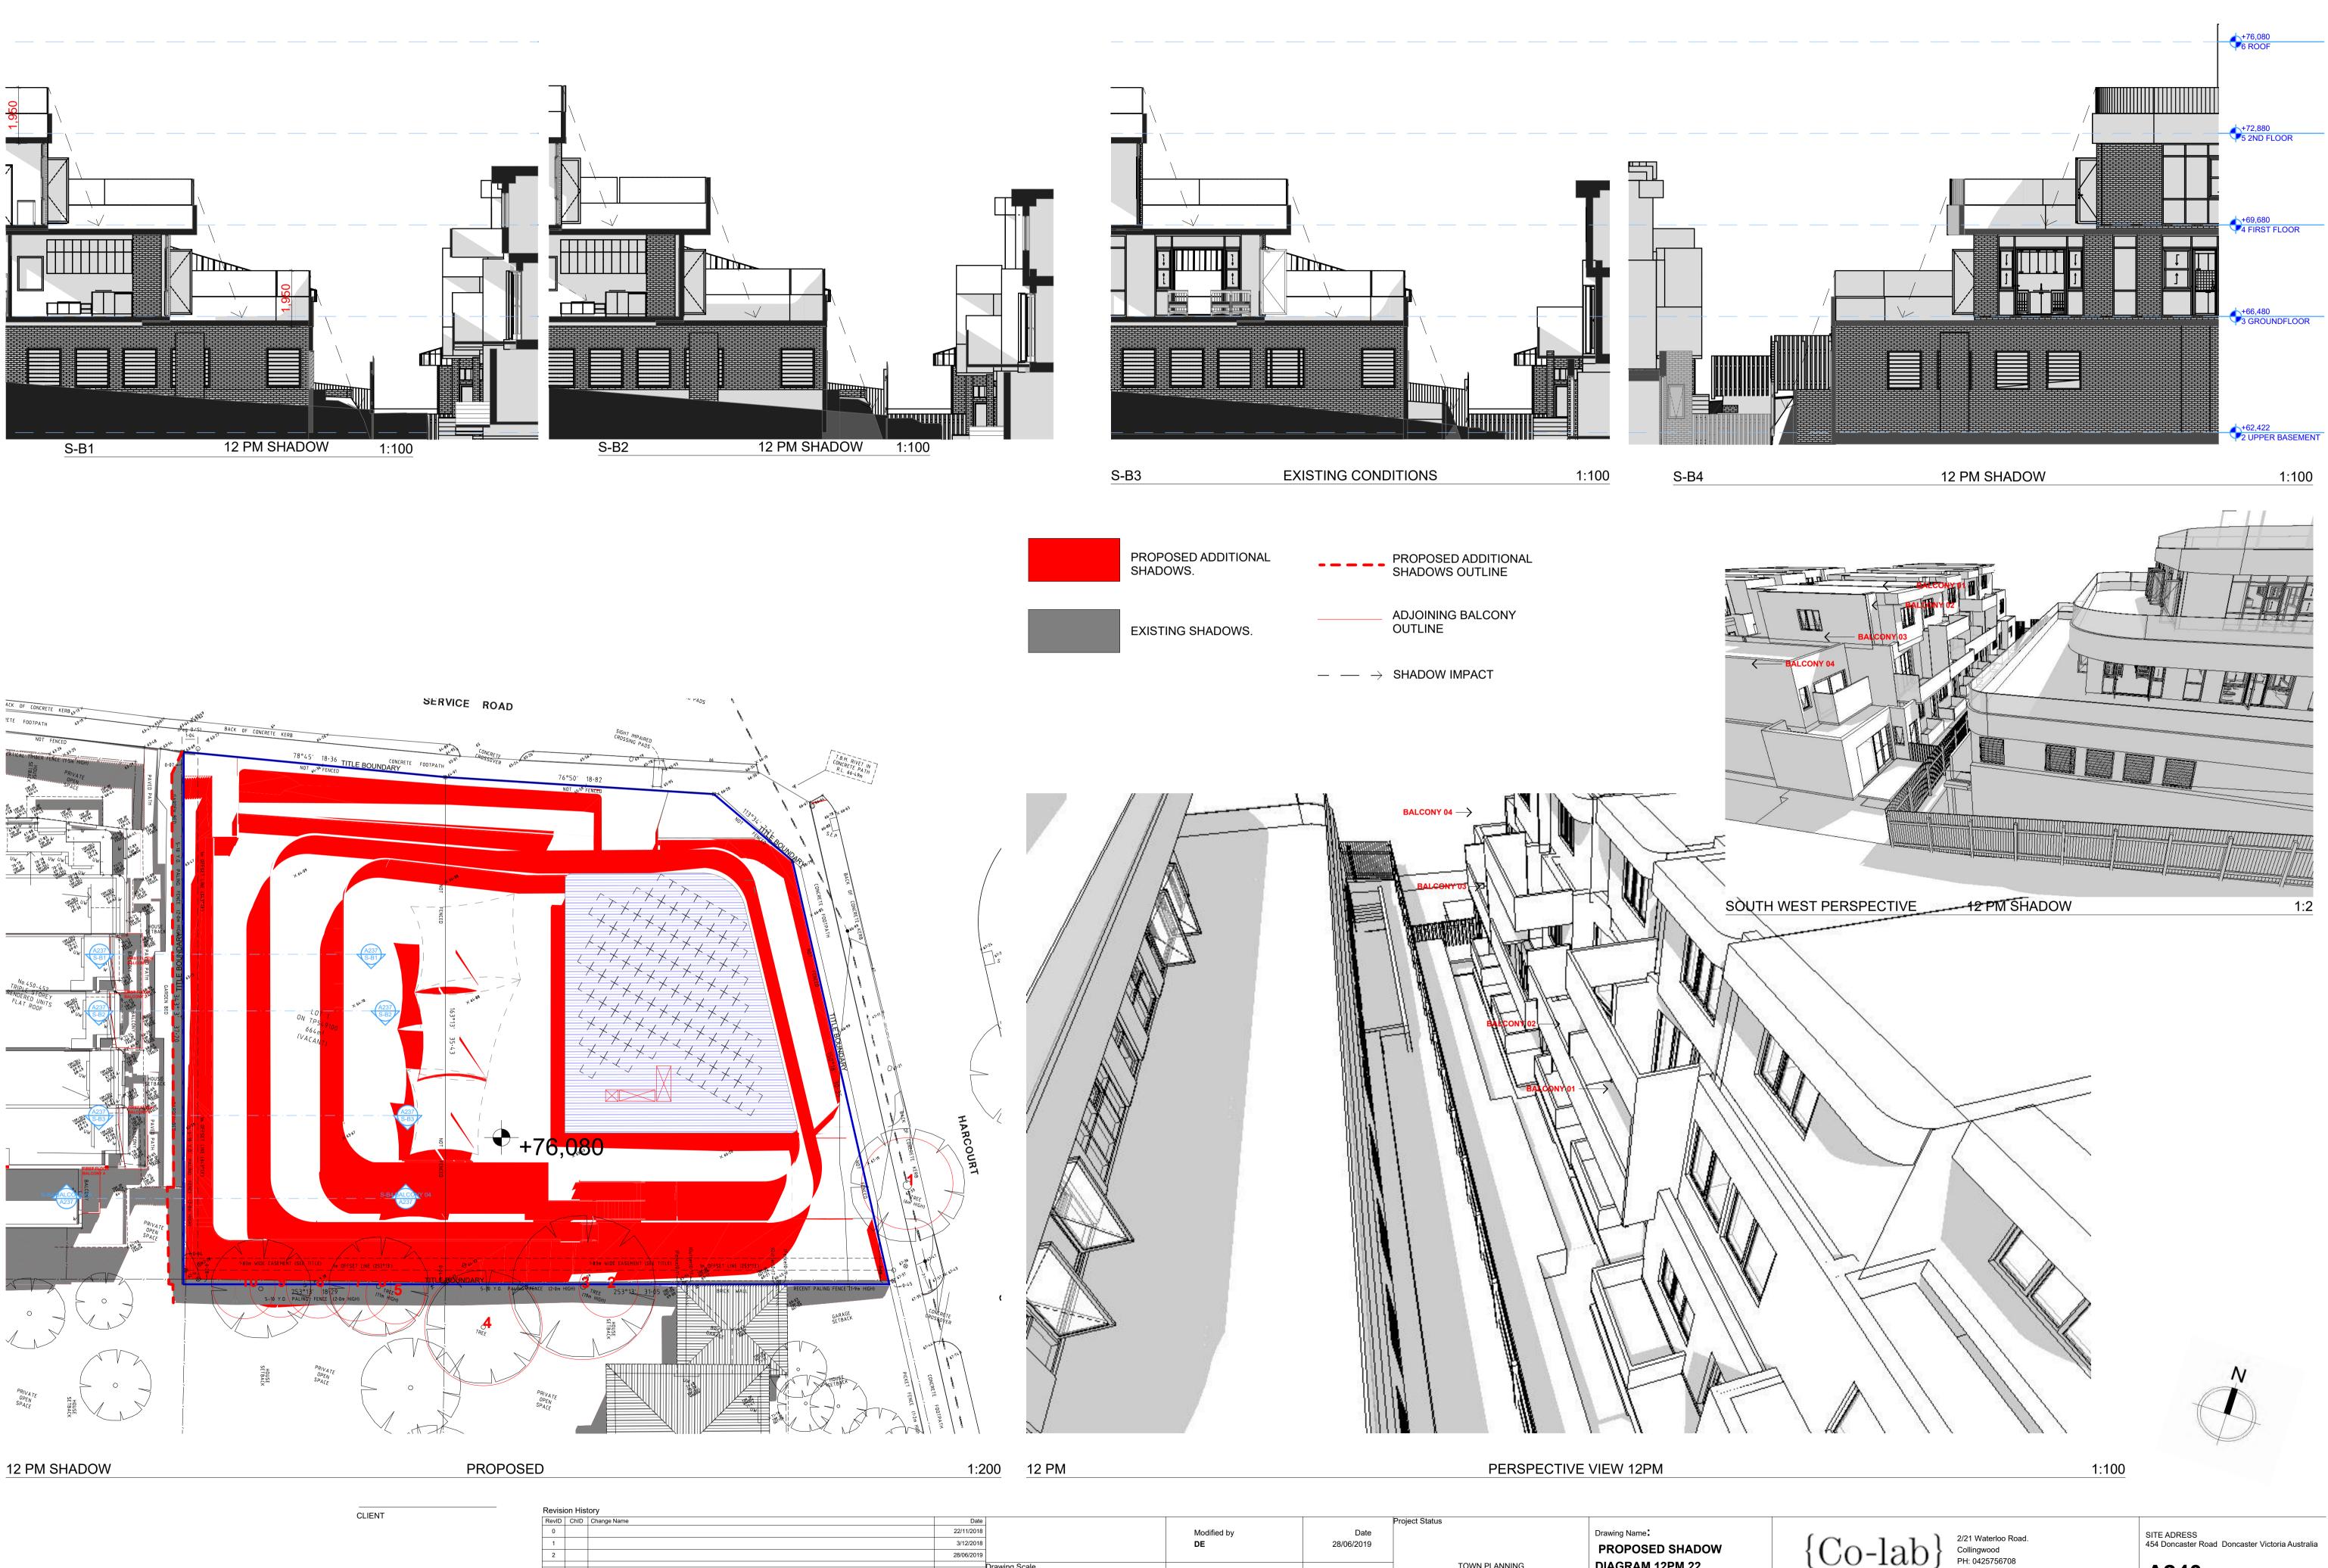

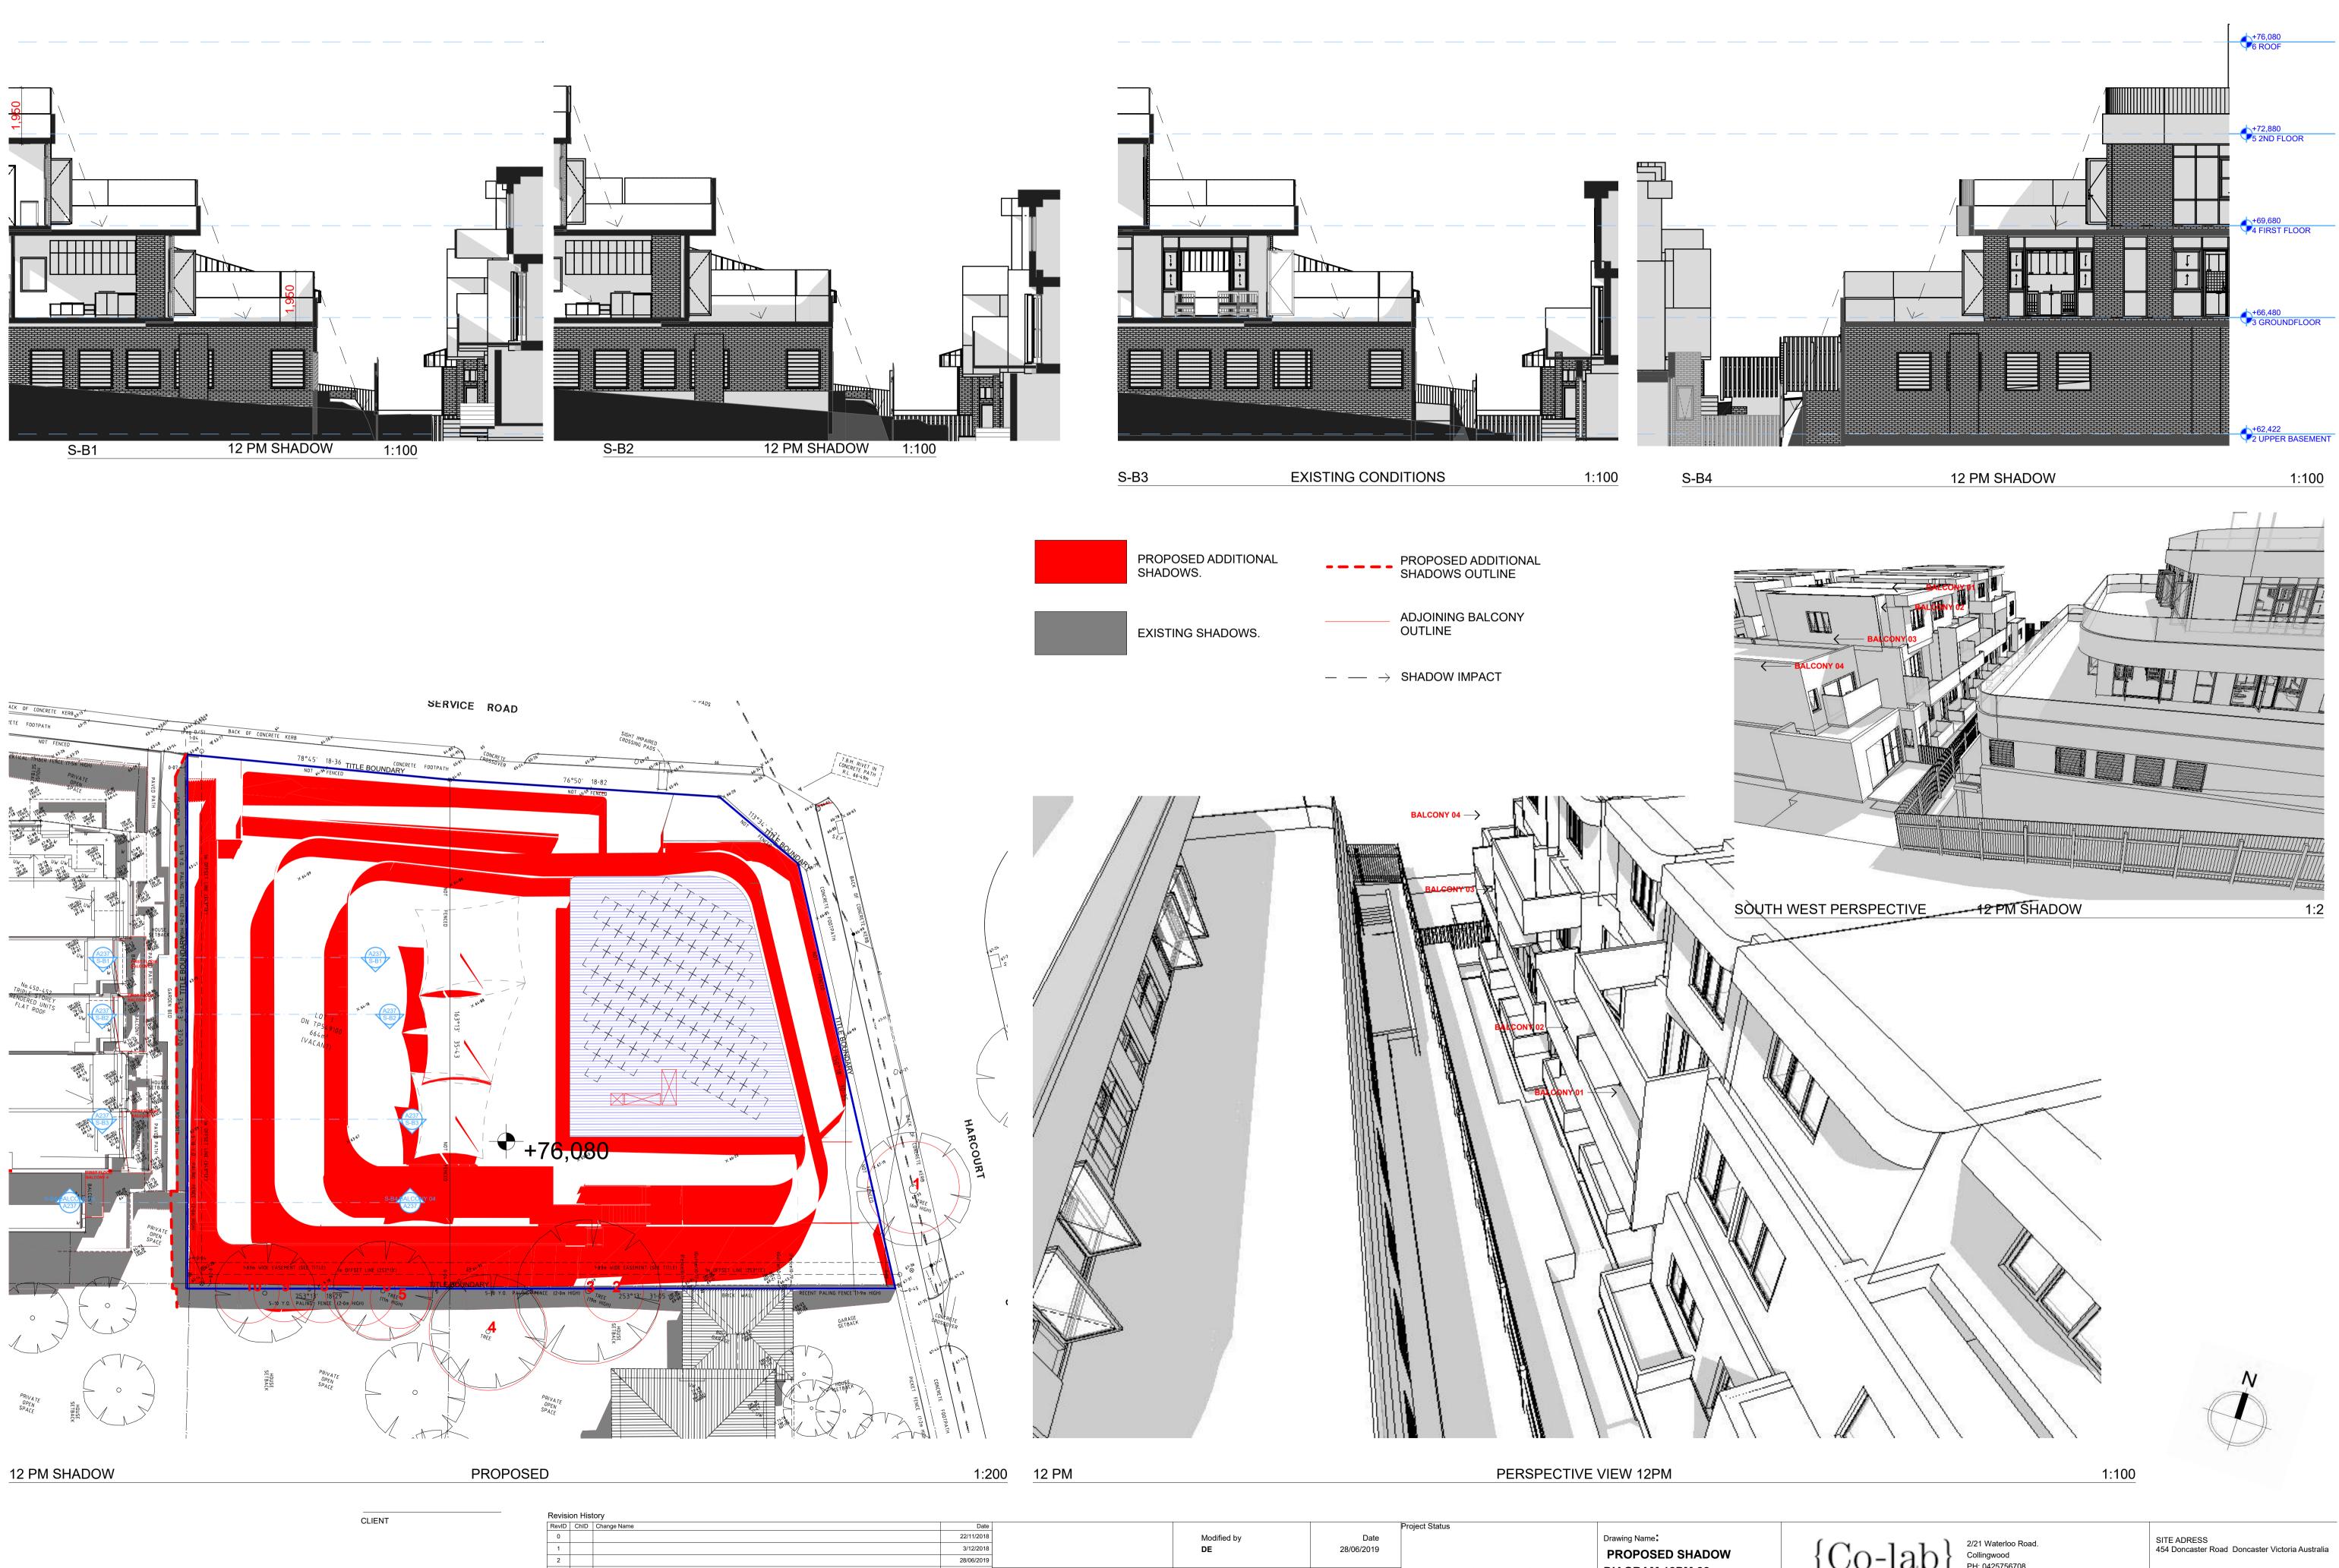


CLIENT	Revisi	on Hist	ory
GLIENT	RevID	ChID	Change Name
	0		
	1		
	2		
	_		
KANE BARNETT			

Date					Project Status	
22/11/2018			Modified by	Date		Drawing Name
3/12/2018			DE	28/06/2019		PROPOSED SHADOW
28/06/2019						FROFUSED SHADOW
	Drawing Scale				TOWN PLANNING	DIAGRAM 12PM 22
			Checked by	Date		
	1:200, 1:100, 1:2 (0	@A1	DE	28/06/2019		SEPTEMBER
			DE	20/00/2010		
	22/11/2018 3/12/2018 28/06/2019	22/11/2018 3/12/2018 28/06/2019 Drawing Scale	22/11/2018 3/12/2018 28/06/2019 Drawing Scale	22/11/2018 Modified by 3/12/2018 DE 28/06/2019 Checked by	22/11/2018 Modified by Date 3/12/2018 DE 28/06/2019 28/06/2019 Drawing Scale Checked by Date	22/11/2018 Modified by Date 3/12/2018 DE 28/06/2019 28/06/2019 Drawing Scale Checked by 1/200 1/400 1/2

2/21 Waterloo Road. Collingwood PH: 0425756708 EMAIL admin@colabarchitects.com.au ABN: 97 150 968 497

ARCHITECTURE

A240 A 4

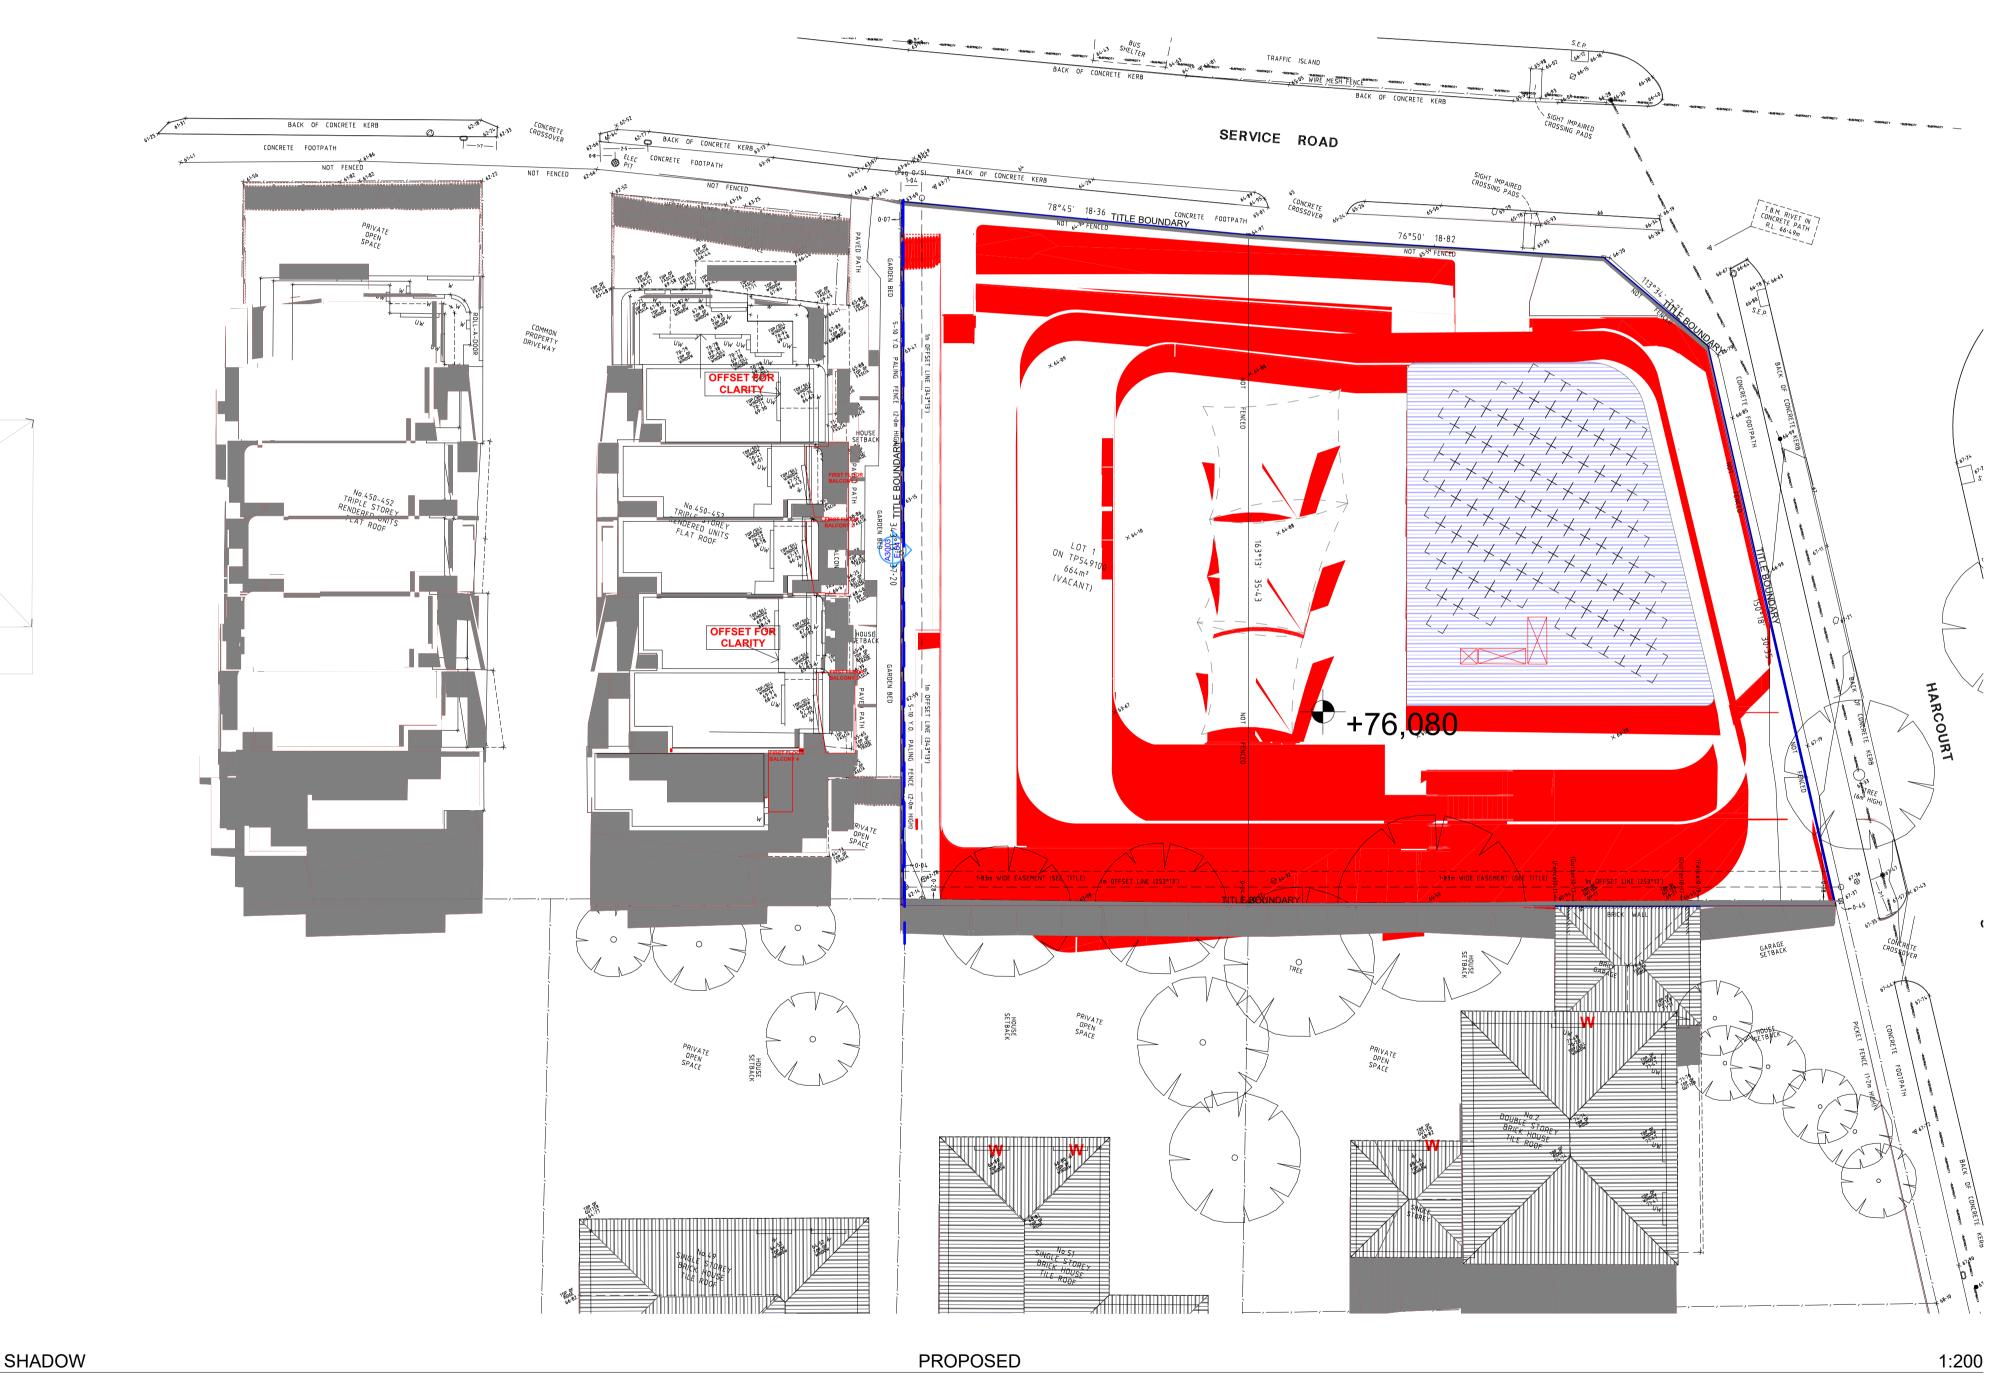

1 PM SHADOW

 Revisi	on Hist	tory
RevID	ChID	Change Name
0		
1		
2		





CLIENT

	Drawing Scale 1:200 @A1	Checked by DE	Date 28/06/2019	TOWN PLANNING	DIAGRAM 1PM 22 SEPTEMBER
28/06/2019					
3/12/2018		DE	28/06/2019		PROPOSED SHADOW
22/11/2018		Modified by	Date		Drawing Name
Date				Project Status	




2/21 Waterloo Road. Collingwood PH: 0425756708 EMAIL admin@colabarchitects.com.au ABN: 97 150 968 497

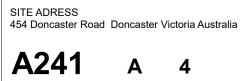


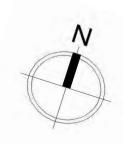

KERB + 6790

(

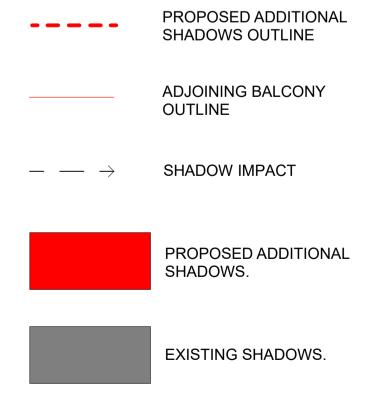

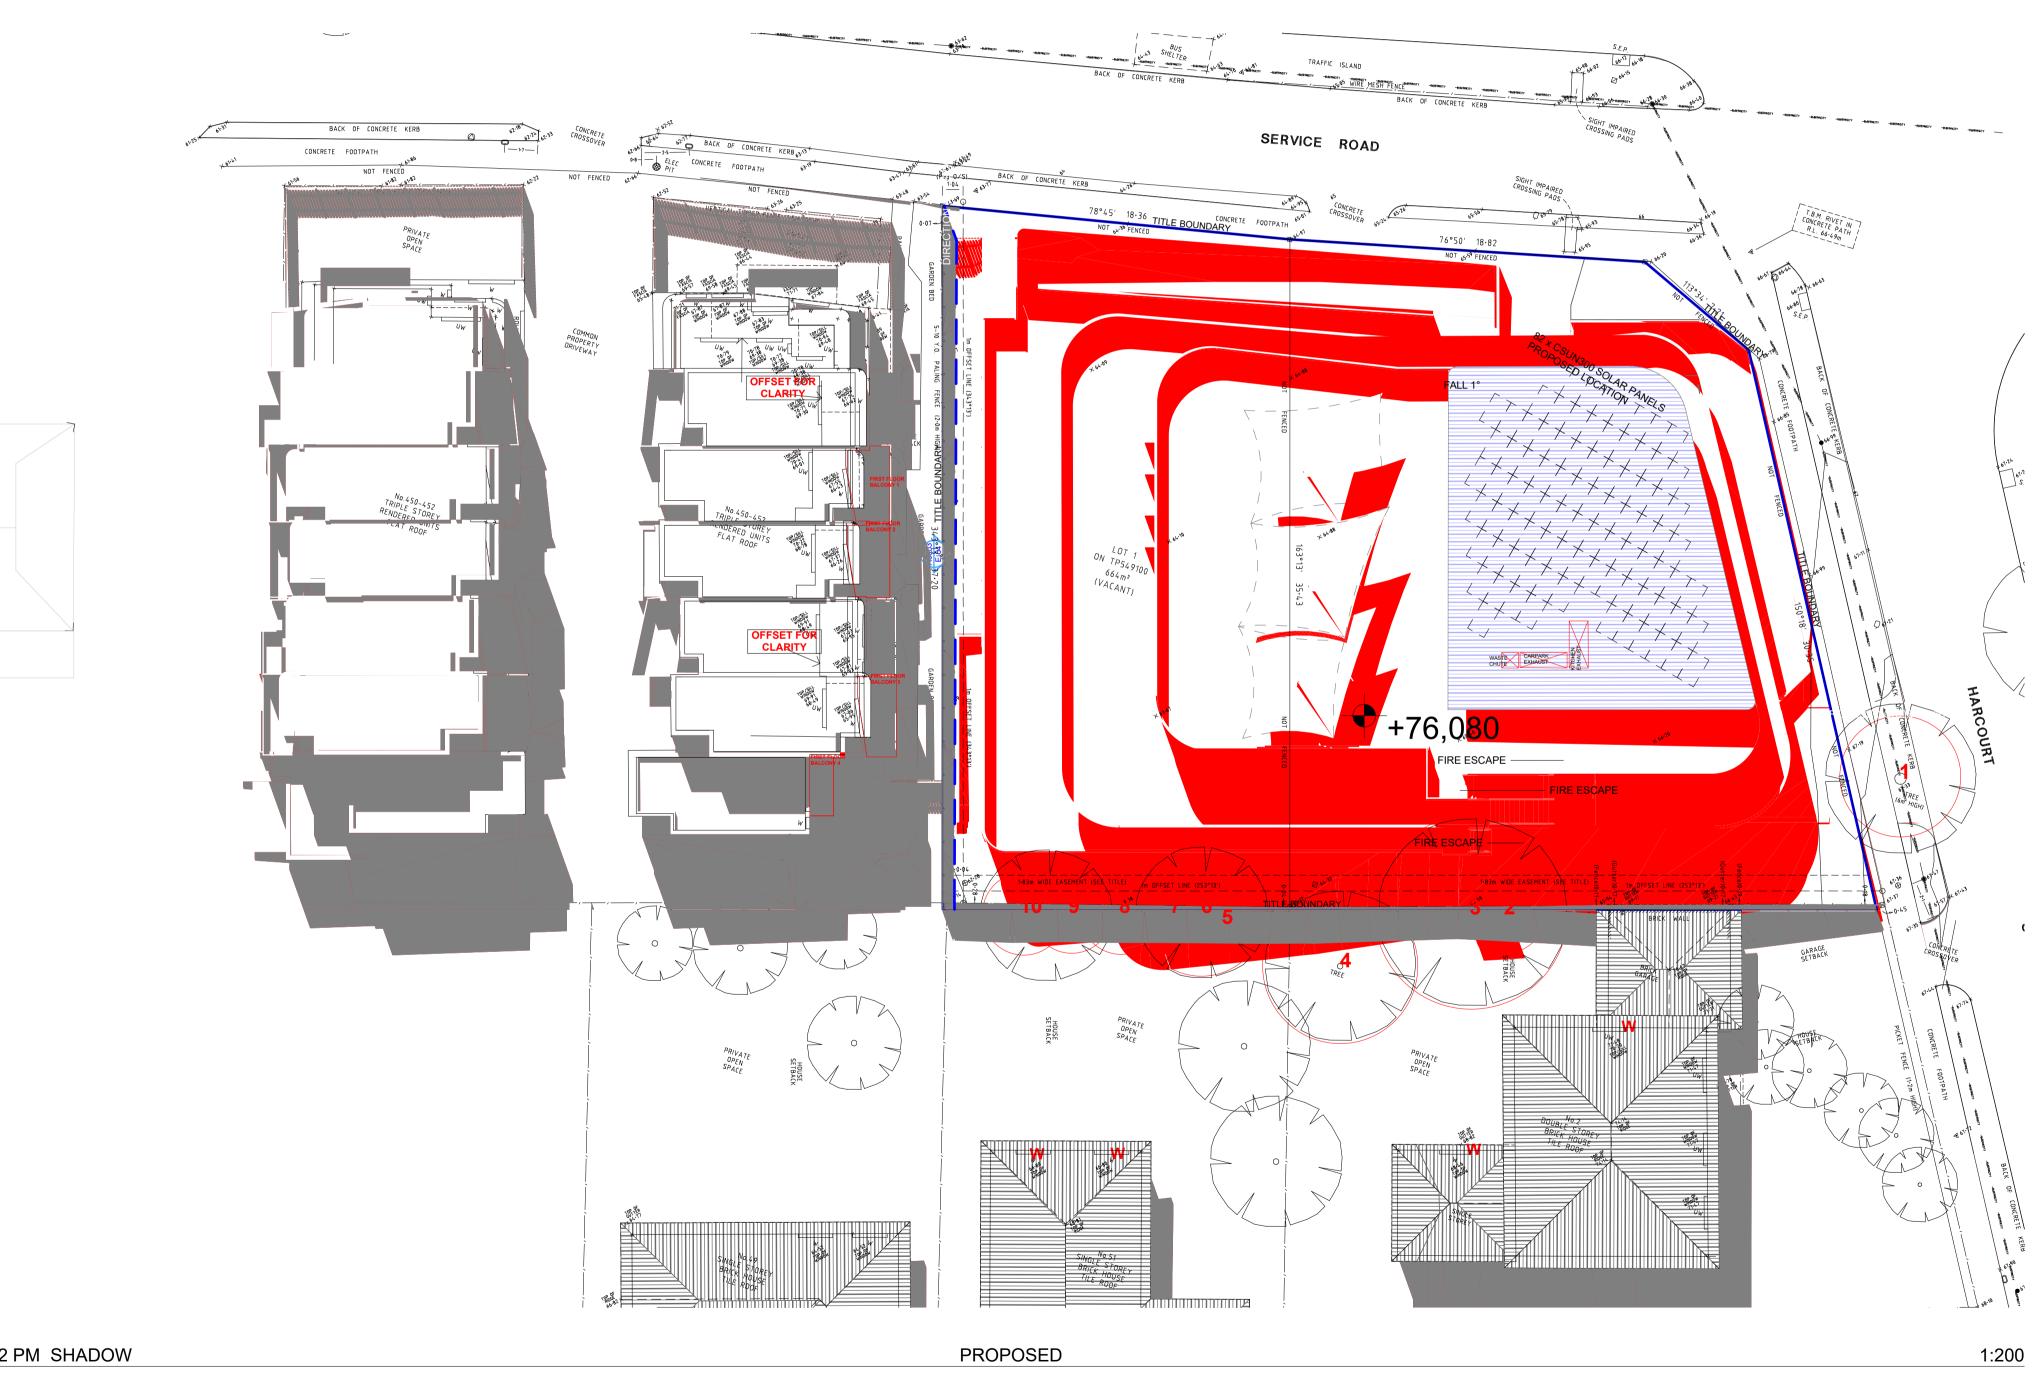

2 PM SHADOW

CLIENT	

Revisi	on Hist	ory
RevID	ChID	Change Name
0		
1		
2		


KANE BARNETT


Date				Project Status	
22/11/2018		Modified by	Date		Drawing Name
3/12/2018		DE	28/06/2019		PROPOSED SHADOW
28/06/2019					
	Prawing Scale	a		TOWN PLANNING	DIAGRAM 2PM 22
	1:200 @A1	Checked by	Date		
	1:200 @A1	DE	28/06/2019		SEPTEMBER



(


2/21 Waterloo Road. Collingwood PH: 0425756708 EMAIL admin@colabarchitects.com.au ABN: 97 150 968 497

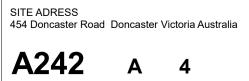

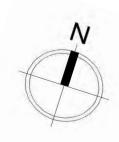

PROPOSED ADDITIONAL SHADOWS OUTLINE ----ADJOINING BALCONY OUTLINE SHADOW IMPACT $- - \rightarrow$ PROPOSED ADDITIONAL SHADOWS.

EXISTING SHADOWS.

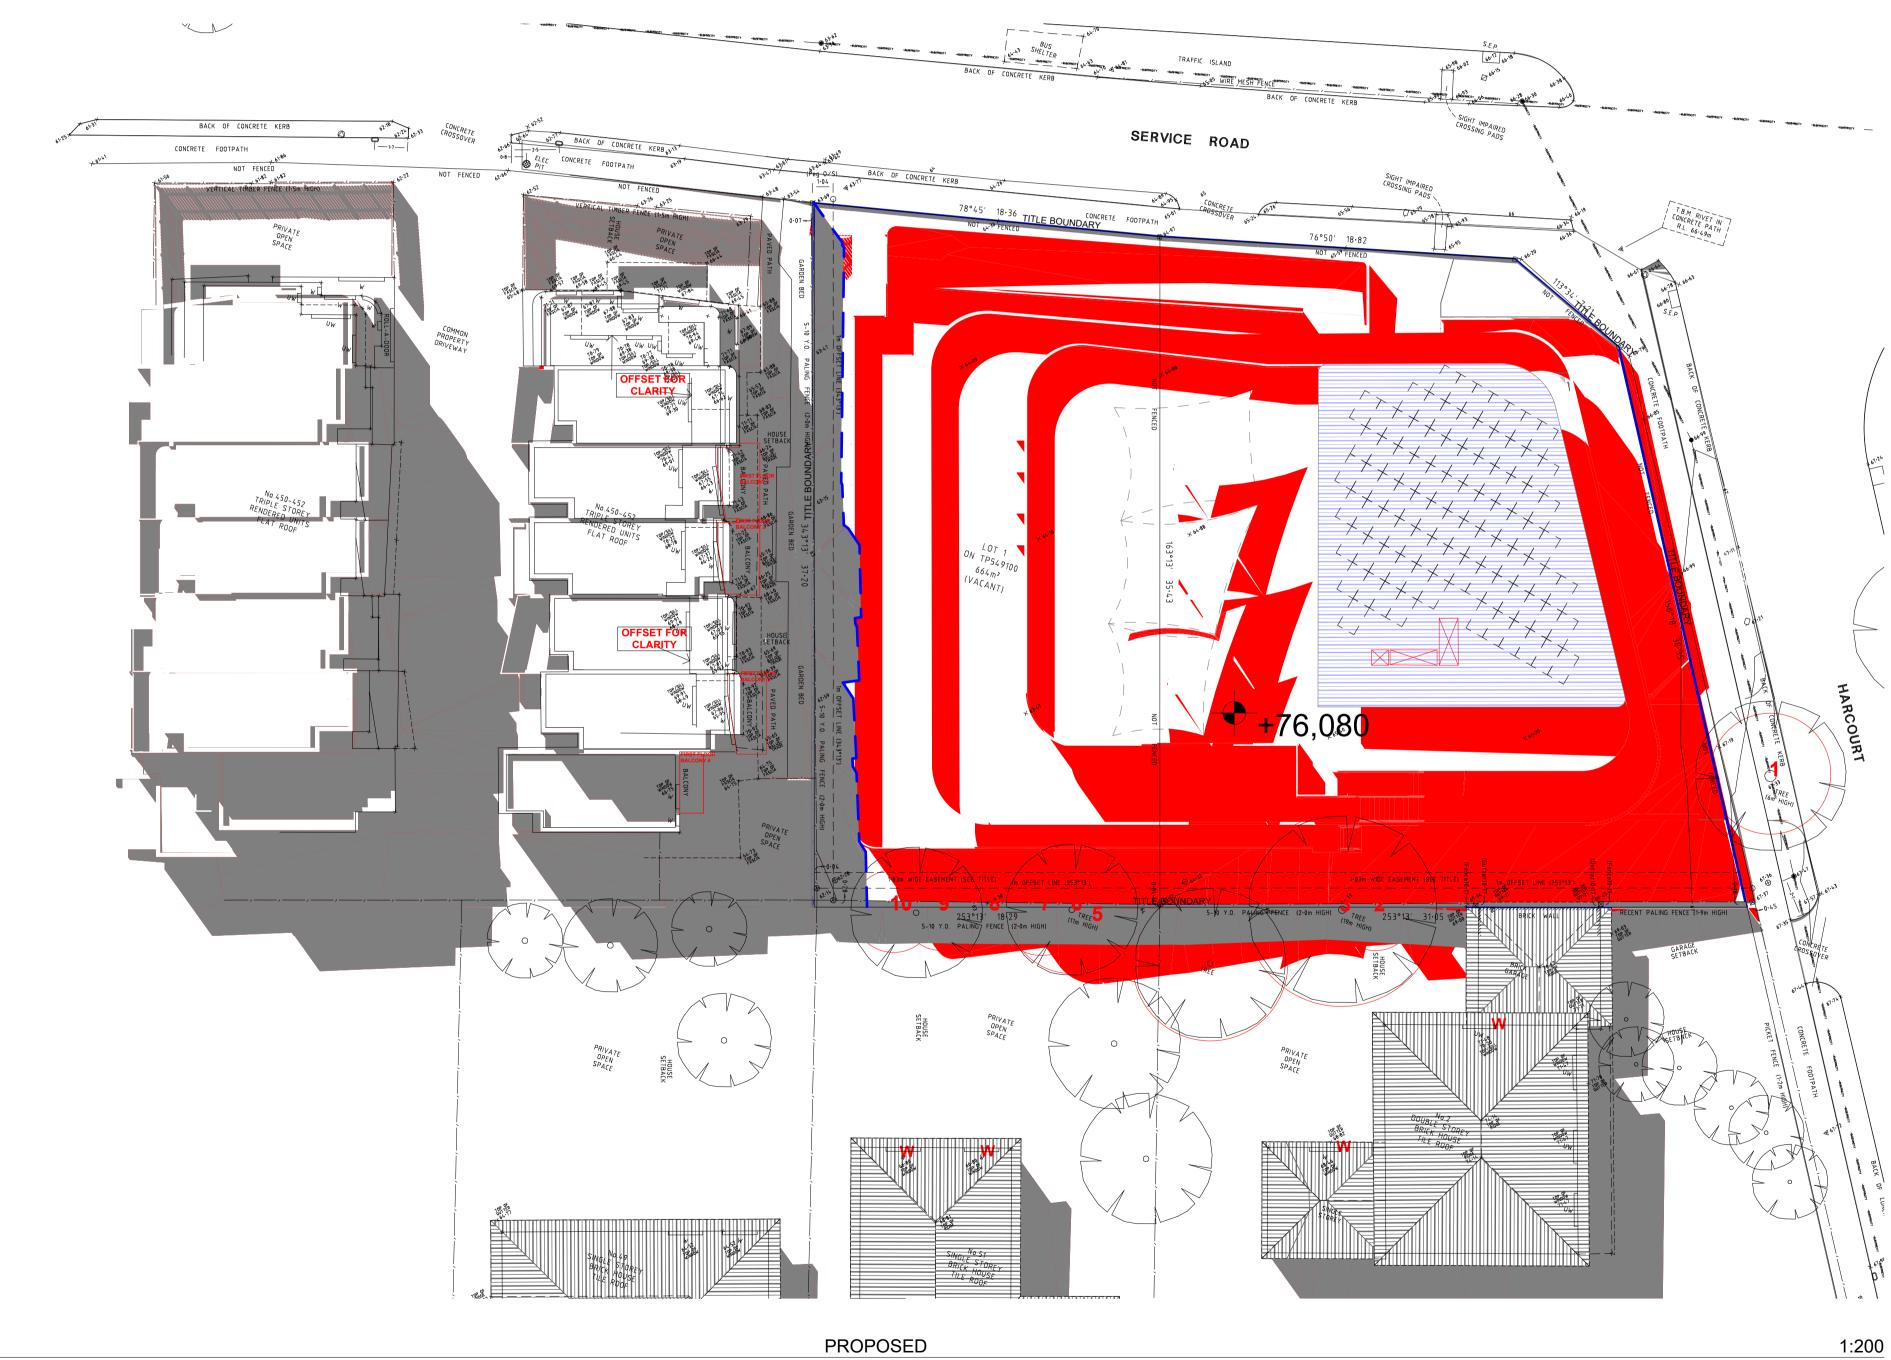

3 PM SHADOW

CLIENT	


	Revision History						
RevID	ChID	Change Name					
0							
1							
2							


KANE BARNETT

	Date			F	Project Status	
	22/11/2018		Modified by	Date		Drawing Name
	3/12/2018		DE	28/06/2019		PROPOSED SHADOW
	28/06/2019		1			FROFUSED SHADOW
		Drawing Scale			TOWN PLANNING	DIAGRAM 3PM 22
		4.000 044	Checked by	Date		
		1:200 @A1	DE	28/06/2019		SEPTEMBER
I						



2/21 Waterloo Road. Collingwood PH: 0425756708 EMAIL admin@colabarchitects.com.au ABN: 97 150 968 497

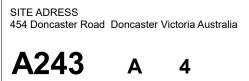

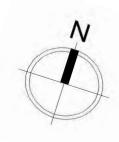

PROPOSED ADDITIONAL SHADOWS OUTLINE ----ADJOINING BALCONY OUTLINE SHADOW IMPACT $- - \rightarrow$ PROPOSED ADDITIONAL SHADOWS. EXISTING SHADOWS.

VERTICAL TIMBER BATTEN SCREEN TO PLAYGROUND PERIMETER WALLS.

MESH SCREENING TO INSIDE OF PLAYGROUND PERIMETER WALL

NOTE:


(GROUND FLOOR ONLY) Immediate fences facing Doncaster Road and Harcourt Street - 1.8m fence to be constructed of a material density of no less than 8kg/m2 with no breaks and batten spacings of 100mm only.

Fences facing Doncaster Road and Harcourt Street - 1.8m fence to be constructed of a material density of no less than 8kg/m2 with no breaks and batten spacings of 100mm with clear acrylic or glass

Fences facing the adjoining properties - 1.8 metre fence to be cosntructed of a materialdensity of no less than 8kg/m2 with no breaks and batten spacings of 100mm allowing a maximum 25% transparency.

FINE WHITE STUCCO FINISH TO PLAY GROUND PERIMITER HOB WALL.

NOTE ALL PLAYGROUND SURFACE FINISHES PLEASE REFER TO LANDSCAPE ARCHITECTS DESIGN LAYOUT AND SPECIFICATION.

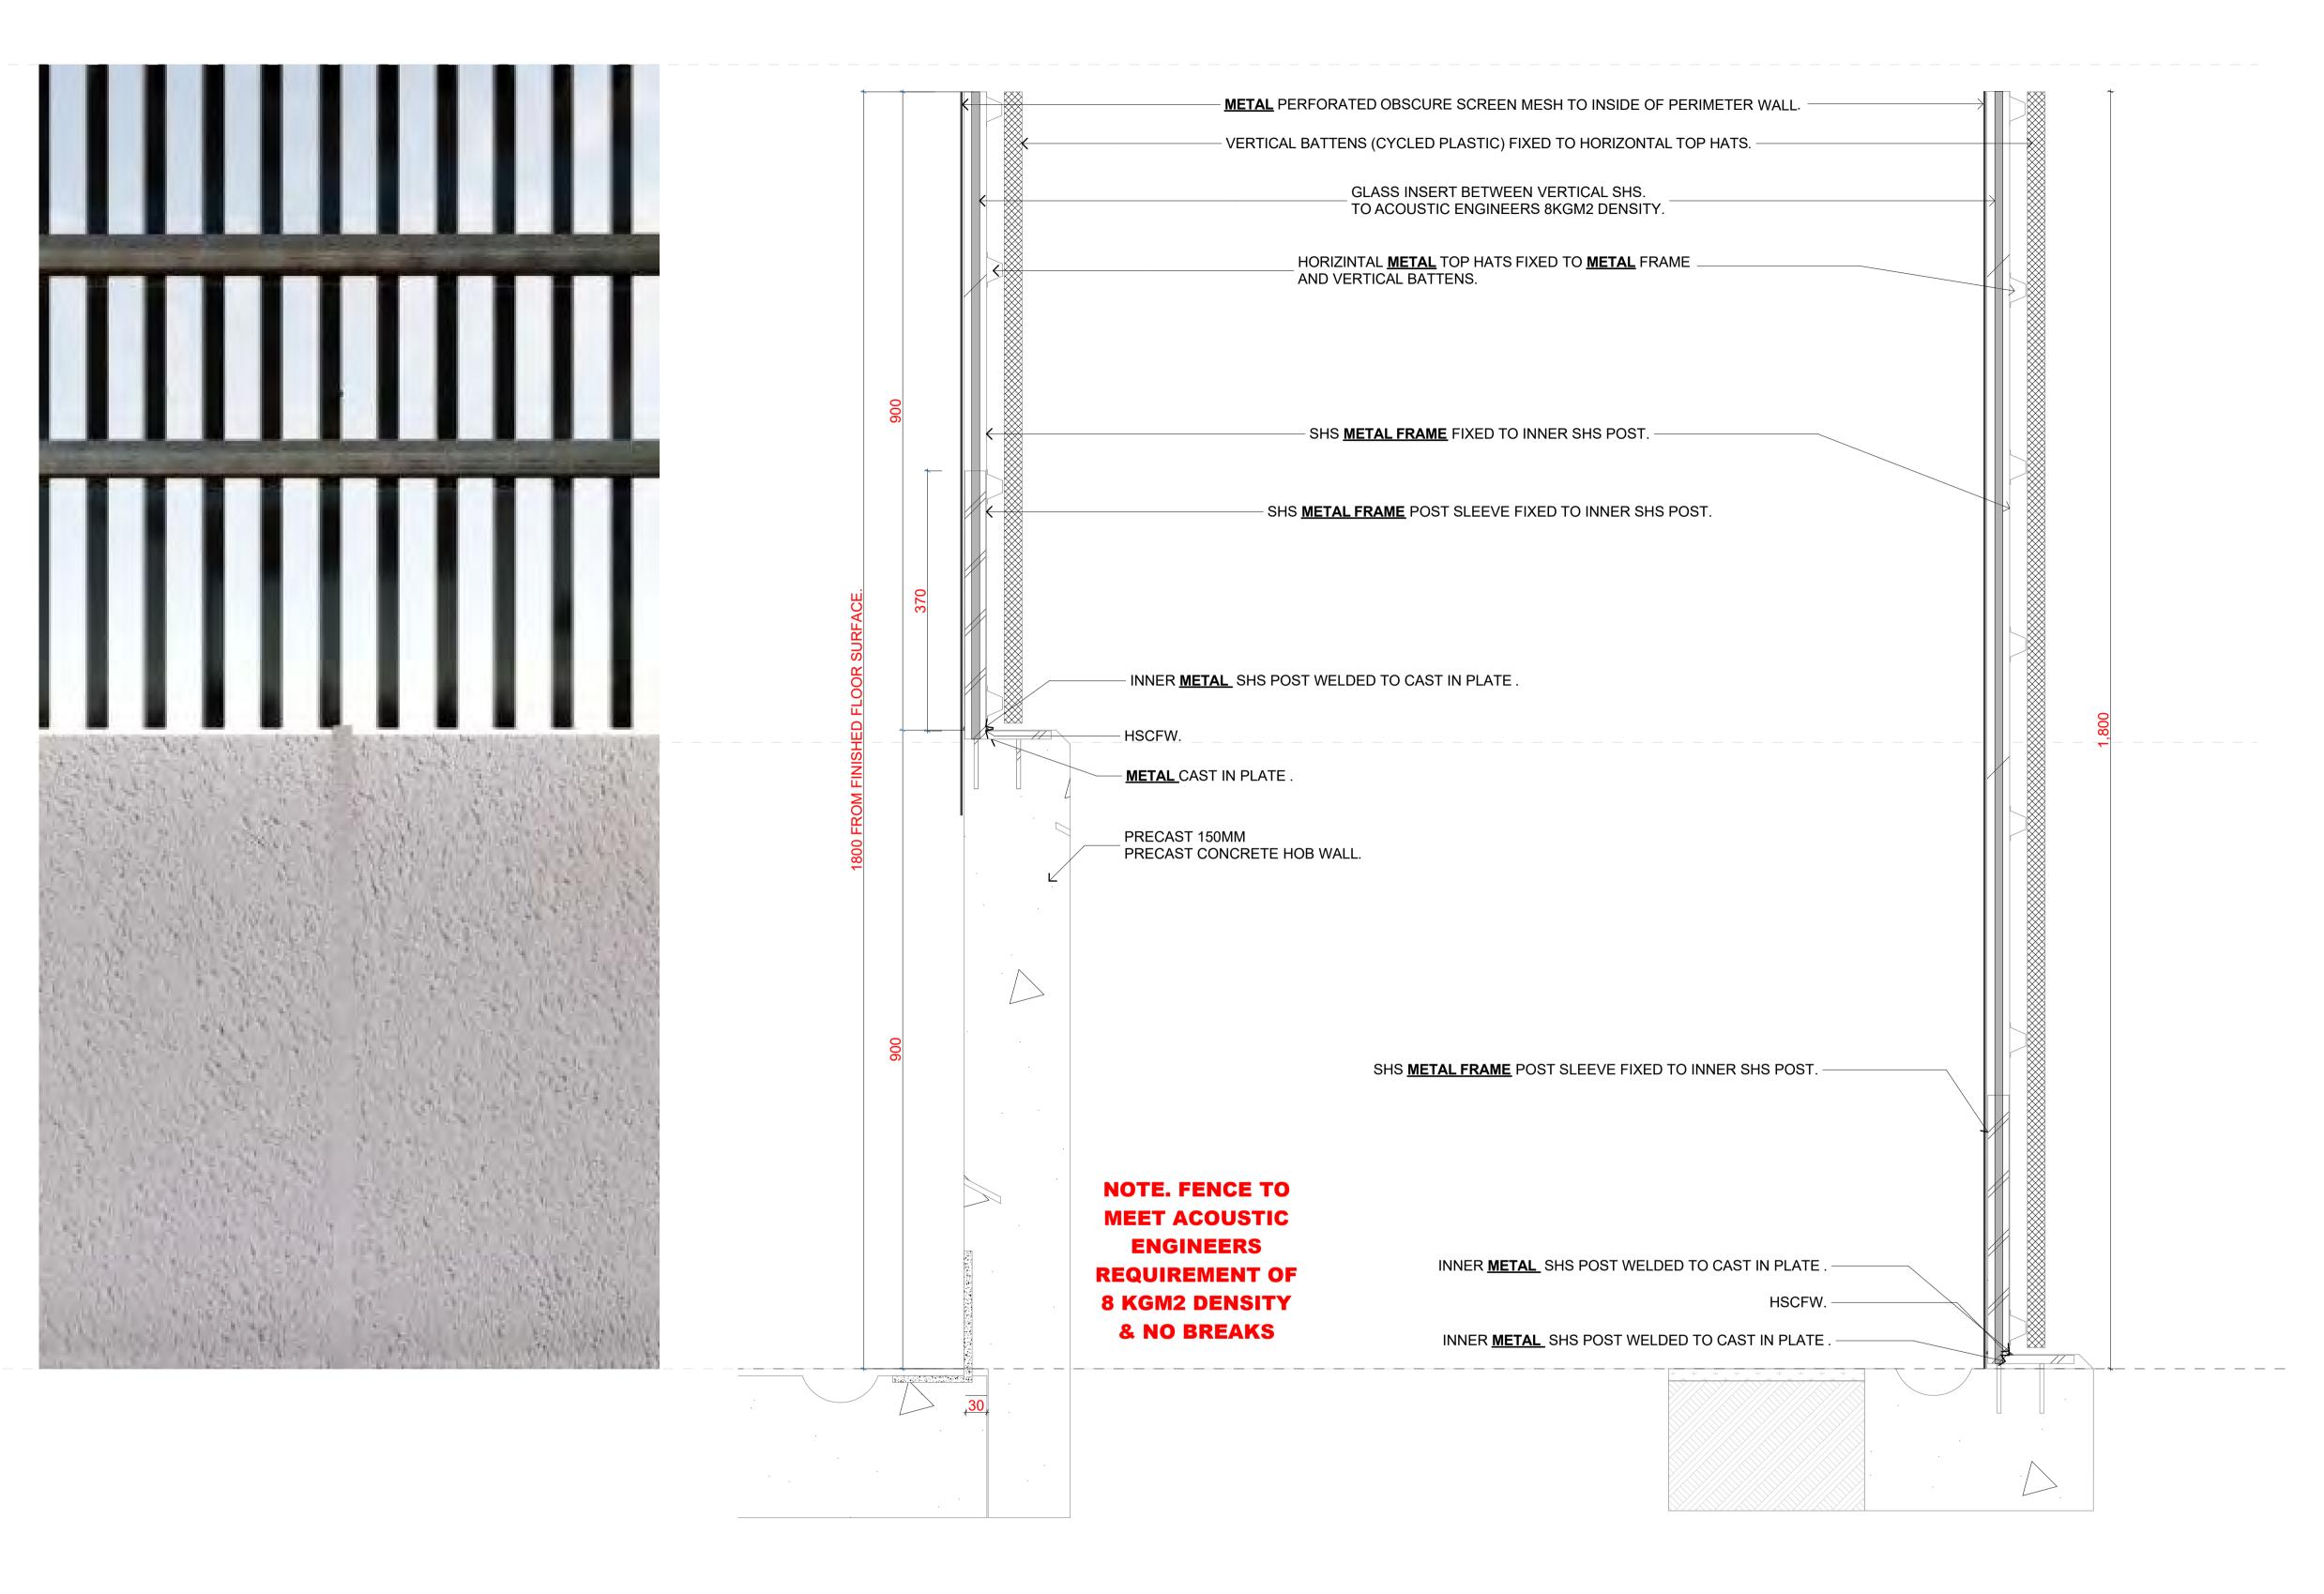



visi	vision History					
٧D	ChID	Change Name				
)						
2						

KANE BARNETT

PLAYGROUND WALL TYPICAL

Date 22/11/2018 3/12/2018 28/06/2019		Modified by DE	Date 28/06/2019	Project Status	Drawing Name: FENCES DETAIL
	Drawing Scale 1:5 @A1	Checked by DE	Date 28/06/2019	TOWN PLANNING	

1:5

{Co-lab}

2/21 Waterloo Road. Collingwood PH: 0425756708 EMAIL admin@colabarchitects.com.au ABN: 97 150 968 497





CLIENT	Revision I	History ID Change Name	
CLIENT	RevID Ch	ID Change Name	
	0		
	1		
	2		
KANE BARNETT			

2860 WIDE

ENTRY SIGNAGE TO LANDSCAPED BUFFER ZONE

	Date				Project Status	
	22/11/2018		Modified by	Date		Drawing Name
	3/12/2018		DE	28/06/2019		SIGNAGE DETAIL
	28/06/2019					SIGNAGE DETAIL
		Drawing Scale			TOWN PLANNING	
		5	Checked by	Date		
		@A1	2			
		WAI .	DE	28/06/2019		
I						

NOTE: LASER CUT ACRYLIC & NON ILLUMINATED LETTERING OR LOGO APPLIED GRAPHIC ONLY, UP LED BY 150 WATT FLOOD LIGHT.

START OF PAVED ENTRY




1390 HIGH

510 FROM NGL

2/21 Waterloo Road. Collingwood PH: 0425756708 EMAIL admin@colabarchitects.com.au ABN: 97 150 968 497



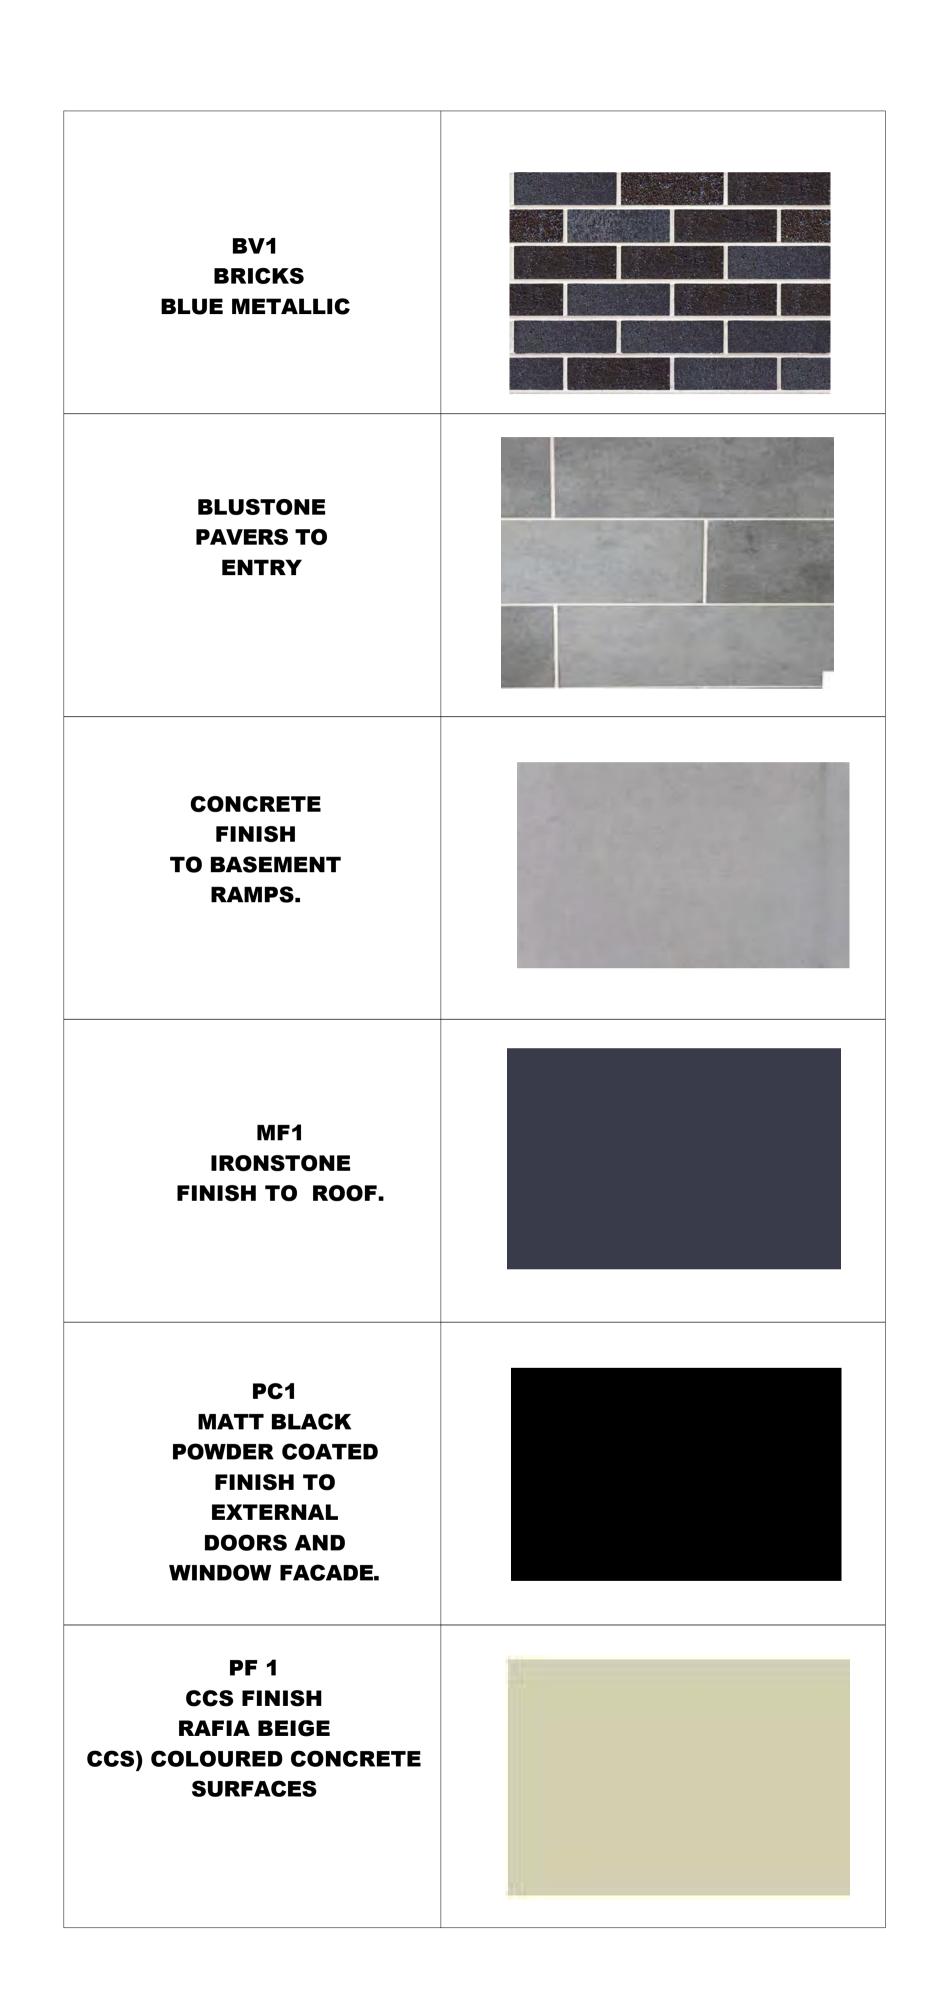

PC1 MATT BLACK **POWDER COATED FINISH TO** EXTERNAL **DOORS AND** WINDOW FACADE.







Layout ID A9002



Date

Date

28/06/2019

4

Checked by Drawing Scale

28/06/2019

Drawing Status

Modified by

DE

DE

SCHEDULES

Drawing Name

454 Doncaster Road Doncaster

Collingwood PH: 0425756708 EMAIL Kane@colabarchitects.com.au ABN: 97 150 968 497

ARCHITECTURE 2/21 Waterloo Road.



RevID	ChID	Change Name	D
2			29/03/20
3			28/06/20

5.. LEGISLATIVE REQUIREMENTS

5.1 PLANNING AND ENVIRONMENT ACT 1987 (THE ACT)

The *Planning and Environment Act 1987* is the relevant legislation governing planning in Victoria. The Act identifies subordinate legislation in the form of Planning Schemes to guide future land use and development.

Section 60 of The *Planning and Environment Act*, requires the Responsible Authority to consider the following before deciding on an application:

- The relevant planning scheme;
- The objectives of planning in Victoria;
- All objections and other submissions which it has received;
- Any decision and comments of a referral authority which it has received; and
- Any significant effects which the responsible authority considers the use or development may have on the environment or which the responsible authority considers the environment may have on the use or development.

Section 61(4) of the Act makes specific reference to covenants. Under Section 61(4) of the *Planning & Environment Act 1987* the Responsible Authority must not issue a planning permit that would result in a breach of a registered restrictive covenant.

5.2 MANNINGHAM PLANNING SCHEME

Clauses of the Manningham Planning Scheme the Responsible Authority must consider:

- Planning Policy Framework
- Local Planning Policy Framework
- Clause 32.07 Residential Growth Zone, Schedule 2
- Clause 43.02 Development and Development Overlay, Schedule 8
- Clause 52.06 Car Parking
- Clause 52.29 Land Adjacent to a Road Zone Category 1 or a Public Acquisition Overlay for a Category 1 Road
- Clause 55 Two or more dwellings on a lot and Residential Buildings
- Clause 65 Decision Guidelines

Zones

<u>Clause 32.08 General Residential Zone, Schedule 2</u> The purpose of the Activity Centre Zone is:

- To implement the State Planning Policy Framework and the Local Planning Policy Framework, including the Municipal Strategic Statement and local planning policies.
- To provide housing at increased densities in buildings up to and including four storey buildings.
- To encourage a diversity of housing types in locations offering good access to services and transport including activity centres and town centres.
- To encourage a scale of development that provides a transition between areas of more intensive use and development and other residential areas.
- To ensure residential development achieves design objectives specified in a schedule to this zone.
- To allow educational, recreational, religious, community and a limited range of other non-residential uses to serve local community needs in appropriate locations.

Permit Requirement:

- A permit is required for the use of a childcare centre (Section 2 use)
- A permit is required to construct or carry out works associated with a Section 2 use.

There is no height restrictions applicable to non-residential buildings (though a 14.5 metre discretionary height is permitted for residential buildings).

Clause 55 is not applicable, however any buildings or works constructed on a lot that abuts land which is in a General Residential Zone, Neighbourhood Residential Zone, or Township Zone must meet the requirements of Clauses 55.03-5, 55.04-1, 55.04-2, 55.04-3, 55.04-5 and 55.04-6 along that boundary.

Overlays

Clause 43.02 Schedule 8 to Design and Development Overlay

The design objectives are as follows:

- To increase residential densities and provide a range of housing types around activity centres and along main roads.
- To encourage development that is contemporary in design that includes an articulated built form and incorporates a range of visually interesting building materials and façade treatments.
- To support three storey, 'apartment style', developments within the Main Road subprecinct and in sub-precinct A, where the minimum land size can be achieved.
- To ensure new development is well articulated and upper storey elements are not unduly bulky or visually intrusive, taking into account the preferred neighbourhood character.
- To encourage spacing between developments to minimise a continuous building line when viewed from a street.
- To ensure the design and siting of dwellings have regard to the future development opportunities and future amenity of adjoining properties.
- To ensure developments of two or more storeys are sufficiently stepped down at the perimeter of the Main Road sub-precinct to provide an appropriate and attractive interface to sub-precinct A or B, or other adjoining zone.
- To ensure overlooking into adjoining properties is minimised.
- To ensure the design of carports and garages complement the design of the building.
- To ensure the design of basement and undercroft car parks complement the design of the building, eliminates unsightly projections of basement walls above natural ground level and are sited to allow for effective screen planting.
- To encourage landscaping around buildings to enhance separation between buildings and soften built form.

Permit Requirement

• A permit is required to construct or carry out works.

Building Height & Setbacks

- Any building or works must comply with the requirements set out in Table 1 and 2 of this Schedule. A permit cannot be granted to vary the maximum building height in Table 2
- For the purposes of this Schedule, the Maximum Building Height does not include building services, lift over-runs and roof mounted equipment, including screening devices.

• For the purposes of this Schedule, balconies, terraces, and verandahs may encroach within the Street Setback by a maximum of 2.0m, but must not extend along the width of the building.

Table 1 (discretionary height requirements)

Sub-Precinct	Maximum Building Height	Condition regarding minimum land size	Street setback
DDO8-1 (Sub- Precinct Main Roads)	11 metres provided the condition regarding minimum land size is met. If the condition is not met, the maximum height is 9 metres, unless the slope of the natural ground level at any cross section wider than eight metres of the site of the building is 2.5 degrees or more, in which case the maximum height must not exceed 10 metres.	1,800 square metres must be all in the same sub-precinct. Where the land comprises more than one lot, the lots must be consecutive lots which are side by side and have a shared frontage.	 For two or more dwellings on a lot or a residential building: Minimum front street setback is the distance specified in Clause 55.03-1 or 6 metres, whichever is the lesser Minimum side street setback is the distance specified in Clause 55.03-1

Policy requirements also relate to form, car parking, landscaping and front fencing.

Planning Policy Framework

The relevant sections of the state planning policy framework are as follows:

Clause 15.01-1 (Urban Design) seeks to create urban environments that are safe, healthy, functional and enjoyable and that contribute to a sense of place and cultural identity.

Strategies towards achieving this are identified as follows:

- Require development to respond to its context in terms of character, cultural identity, natural features, surrounding landscape and climate.
- Ensure development contributes to community and cultural life by improving the quality of living and working environments, facilitating accessibility and providing for inclusiveness.
- Ensure the interface between the private and public realm protects and enhances personal safety.
- Ensure development supports public realm amenity and safe access to walking and cycling environments and public transport.
- Ensure that the design and location of publicly accessible private spaces, including car parking areas, forecourts and walkways, is of a high standard, creates a safe environment for users and enables easy and efficient use.
- Ensure that development provides landscaping that supports the amenity, attractiveness and safety of the public realm.
- Ensure that development, including signs, minimises detrimental impacts on amenity, on the natural and built environment and on the safety and efficiency of roads.
- Promote good urban design along and abutting transport corridors.

Clause 15.01-2 (Building Design) policy objective is:

• To achieve building design outcomes that contribute positively to the local context and enhance the public realm.

The strategies to achieve this requires a comprehensive site analysis prior to the design process, requires developments to respond to strategic and cultural context of its locations, minimise detrimental impact on neighbouring properties and encourages landscaping that enhances the built form and create safe attractive spaces.

Clause 15.01-4 (Healthy Neighbourhoods) policy objective is:

• To achieve neighbourhoods that foster healthy and active living and community wellbeing.

Strategies to achieve the objective include designing neighbourhoods that foster community interaction and making it easy for people of all ages to live healthy lifestyles by providing connected, safe and attractive walking and cycling networks, conveniently locating public spaces for active recreation, providing accessibly located public transport stops and streets with direct, safe and convenient access to destinations.

Clause 15.01-5 (Neighbourhood Character) policy objective is:

• To recognise, support and protect neighbourhood character, cultural identity and sense place.

The clause includes several strategies to achieve this objective, including to:

- Ensure development responds to cultural identity and contributes to existing or preferred neighbourhood character.
- Ensure development responds to its context and reinforces a sense of place and the valued features and characteristics of the local environment and place by emphasising the:
 - Pattern of local urban structure and subdivision
 - Underlying natural landscape character and significant vegetation.
 - Heritage values and built form that reflect community identity.

Clause 15.02-1 Sustainable Development: Energy and resource efficiency The policy objective is:

• To encourage land use and development that is energy and resources efficient, supports a cooler environment and minimises greenhouse gas emissions.

The clause has the following strategies:

- Improve the energy, water and waste performance of buildings and subdivisions through environmentally sustainable development.
- Promote consolidation of urban development and integration of land use and transport. Improve efficiency in energy use through greater use of renewable energy technologies and other energy efficiency upgrades.
- Support low energy forms of transport such as walking and cycling.
- Reduce the urban heat island effect by greening urban areas, buildings, transport corridors and open spaces with vegetation.
- Encourage retention of existing vegetation and planting of new vegetation as part of development and subdivision proposals.

Clause 18.01-1 Integrated Transport: Land use and transport planning The policy objective is:

• To create a safe and sustainable transport system by integrating land-use and transport.

Clause 18.02-1 Movement networks: Sustainable personal transport The policy objective is:

• To promote the use of sustainable personal transport.

Clause 18.02-2R Principal Public Transport Network The policy objective is:

• To maximise the use of existing infrastructure and increase the diversity and density of development along the Principal Public Transport Network, particularly at interchanges, activity centres and where principal public transport routes intersect.

Clause 19.02-2 Community Infrastructure: Education Facilities The policy objective is:

• To assist the integration of education and early childhood facilities with local and regional communities.

The clause includes several strategies to achieve this objective, they include:

- Consider demographic trends, existing and future demand requirements and the integration of facilities into communities in planning for the location of education and early childhood facilities.
- Locate childcare, kindergarten and primary school facilities to maximise access by public transport and safe walking and cycling routes.
- Ensure childcare, kindergarten and primary school facilities provide safe vehicular dropoff zones.
- Locate secondary school and tertiary education facilities in designated education precincts and areas that are highly accessible to public transport.
- Locate tertiary education facilities within or adjacent to activity centres.
- Ensure streets and accessways adjoining education and early childhood facilities are designed to encourage safe bicycle and pedestrian access.
- Develop libraries as community based learning centres.

Local Planning Policy Framework (LPPF)

Municipal Strategic Statement

Clause 21.02 Municipal Profile

Manningham is close to a number of tertiary institutions in city and suburban locations, which provide employment and further education opportunities. The municipality offers social and cultural opportunities and community services which attract people from the broader regional context.

It is projected that by 2031, Manningham will have an estimated resident population of 136,300 people. It is anticipated that an additional 20,600 people will take residence in Manningham between 2006 and 2031 (forecast.id).

Clause 21.05 Residential

This policy outlines the division of Manningham into four Residential Character Precincts. The precincts seek to channel increased housing densities around activity centres and main roads where facilities and services are available. In areas which are removed from these facilities a lower intensity of development is encouraged. A low residential density is also encouraged in areas that have identified environmental or landscape features.

The site is within Precinct 2 – Residential Areas Surrounding Activity Centres and Along Main Roads.

A substantial level of change is anticipated in Precinct 2. A substantial level of change is anticipated in Precinct 2 with these areas being a focus for higher density developments. Economic development issues include objectives to encourage uses with a community service role in close proximity to activity centres or other community based facilities.

Non-residential uses and commercial developments which do not have a community service role are discouraged from locating in residential areas. Commercial development remote from activity centres is also discouraged in order to protect the amenity of residential areas, the viability of activity centres and to ensure the safe and efficient functioning of the road network.

The site is located within Sub-Precinct: Main Roads.

The Main Roads Sub-Precinct is an area where three storey (11m), contemporary 'apartment style' developments are supported on land with a minimum area of 1,800sqm. All development in sub-precinct should have a maximum site coverage of 60 percent. Higher developments on the perimeter of another zone should be designed so that the height and form are sufficiently stepped down to compliment the scale and form of adjoining residential areas.

Development in Precinct 2 should:

- Provide for contemporary architecture
- Achieve high design standards
- Provide visual interest and make a positive contribution to the streetscape
- Provide a graduated building line from side and rear boundaries
- Minimise adverse amenity impacts on adjoining properties
- Use varied and durable building materials
- Incorporate a landscape treatment that enhances the overall appearance of the development.
- Integrate car parking requirements into the design of buildings and landform.

Clause 21.10 Ecologically Sustainable Development

This policy highlights Council's commitment to ESD and outlines a number of ESD principles to which regard must be given. These include building energy management, water sensitive design, external environmental amenity, waste management, quality of public and private realm and transport.

Local Planning Policy

Clause 22.05 Non-Residential Uses in Residential Areas

This policy applies to non-residential uses in a Residential Growth Zone, General Residential Zone, Neighbourhood Residential Zone and Low Density Residential Zone.

The residential Growth Zone is are encouraged to accommodate a range of non-residential uses that service local community needs. The key aim is to balance the need for residents to access services in residential locations while ensuring that residential amenity is not adversely affected by way of high levels of on-site activity, traffic generation, noise emission, odour, light and visual disorder. Key preferences for locating these facilities are

Clause 22.08 Safety through urban design

This policy applies to all land in Manningham. It endeavours to provide and maintain a safer physical environment for those who live in, work in or visit the City of Manningham. The policy seeks attractive, vibrant and walkable public spaces where crime, graffiti and vandalism in minimised.

Clause 22.09 Access for disabled people

This policy also applies to all land in Manningham. It seeks to ensure that people with a disability have the same level of access to buildings, services and facilities as any other person. The policy requires the needs of people with a disability to be taken into account in the design of all proposed developments.

Clause 22.12 Environmentally Sustainable Development

This policy applies throughout the City of Manningham to residential and non-residential development that requires a planning permit in accordance with the thresholds in Table 1 of this Policy (except for land affected by the Activity Centre Zone (Schedule 1) that applies to Doncaster Hill). The policy contains an overarching objective that development should achieve best practice in environmentally sustainable development from the design stage through to construction and operation.

Particular Provisions

Clause 52.06 Car Parking

Pursuant to Clause 52.06-5, car parking is required to be provided at the following rates

• 0.22 space to each child.

The **49** spaces provided on site exceeds the statutory requirement for **43** spaces, and therefore a permit is not required to reduce the standard car parking requirements.

Clause 52.06-9 outlines various design standards for parking areas that should be achieved.

<u>Clause 52.29 Land Adjacent to a Road Zone, Category 1, or a Public Acquisition Overlay for</u> <u>a Category 1 Road</u>

The purpose of this clause is:

- To ensure appropriate access to identified roads.
- To ensure appropriate subdivision of land adjacent to identified roads.

A permit is required to create or alter access to a road in a Road Zone, Category 1.

Clause 55 Two or more dwellings on a lot and Residential Buildings

A development:

- Must meet all of the objectives of this clause
- Should meet all of the standards of this clause.

This provision is not applicable to non-residential buildings, however select requirements as specified in the RGZ are to be met.

General Provisions

Clause 65 Decision Guidelines

This clause outlines that before deciding on an application, the responsible authority must consider, as appropriate:

- The Municipal Planning Strategy and the Planning Policy Framework.
- The purpose of the zone, overlay or other provision.
- Any matter required to be considered in the zone, overlay or other provision.
- The orderly planning of the area.
- The effect on the amenity of the area.
- Whether the proposed development is designed to maintain or improve the quality of stormwater within and exiting the site.
- The degree of flood, erosion or fire hazard associated with the location of the land and the use, development or management of the land so as to minimise any such hazard.